

1. All erosion and sediment control work shall conform to standards and specifications of the WAYNE County Drain Commissioner. 2. All temporary and permanent (post construction) soil erosion and sediment control measures shall conform to the City of WAYNE current MS4 permit. Any conflict between these standards and the MS4 permit, the permit's conditions shall take precedence.

3. Daily inspections shall be made by the Contractor for effectiveness of erosion and sedimentation control measures, and any necessary repairs shall be performed without delay.

4. Any sedimentation from work on this site shall be contained on the site and not allowed to collect on any off-site areas or in waterways. 5. Contractor shall apply temporary erosion and sedimentation control measures when required and as directed on these plans. Temporary measures shall be

removed as soon as permanent stabilization of slopes, ditches, and other earth changes have been accomplished per WAYNE County Drain Commissioner's standards. This would include temporary sedimentation ponds and temporary SO2 filters.

6. Staging the work will be done by the Contractor as directed in these plans and as required to ensure progressive stabilization of disturbed earth.


7. Soil erosion control practices shall be established in the early stages of construction by the Contractor. Sediment control practices will be applied as a perimeter defense against any transporting of silt off the site.


8. Failure to comply with approved soil erosion and sedimentation measures may result in work stoppage by appropriate authority.


9. Exceptions to timing of control measures' installation will only be permitted where trees and stumps need to be removed to install soil erosion and sedimentation control measures.

10. Contractor is to provide the City with permit renewals, violation corrections, and/or releases.

SILT FENCE DETAIL <u>LEGEND</u> STONE TRACKING PAD WITH GEOTEXTILE LINER RIP RAP WITH GEOTEXTILE LINER CATCH BASIN "CATCH-ALL INLET BAG FILTER"- STREET CATCH BASIN "CATCH-ALL INLET BAG FILTER" - YARD SILT FENCE

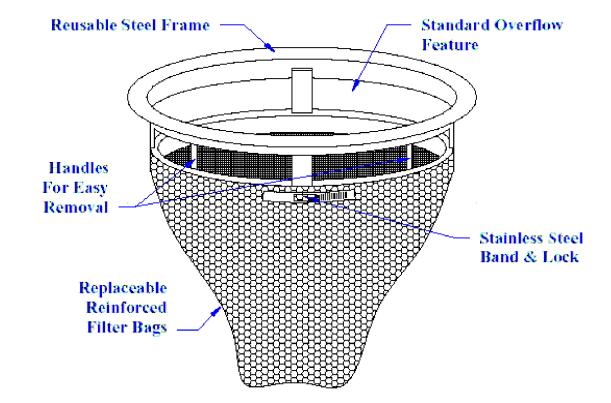


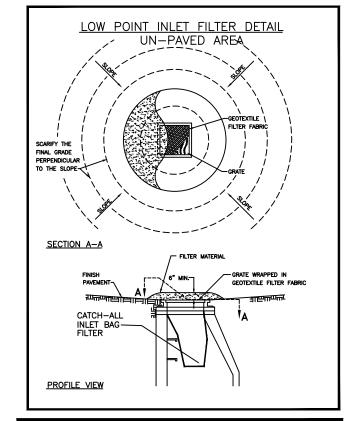


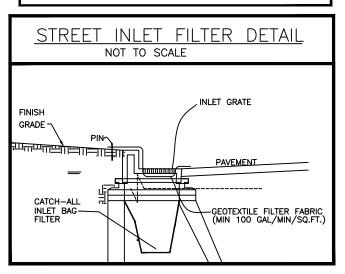

IND-1

EXISTING

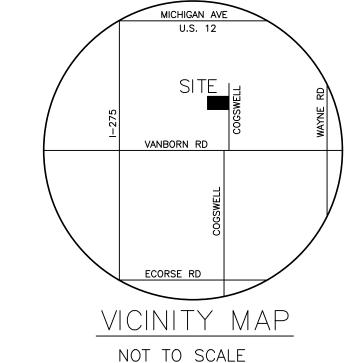

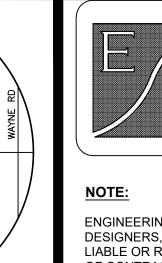

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CONSULTING ENGINEERS

32190 SCHOOLCRAFT ROAD,

(734) 525-7330

ARCHITECTURAL, CIVIL, ENVIRONMENTAL COMPLIANCE

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ESI_CORP@YAHOO.COM

LIVONIA, MICHIGAN 48150

I hereby certify that this plan and specification was prepared by me or under my direct supervision and that I am a duly registered Architect or Engineer under the Laws of the State of Michigan by my hand and seal.



G SIDHU TRUCKING

VACANT PROPERTY PARCEL #55-011-99-0010-701

5300 COGSWELL ROAD CITY OF WAYNE, MI 48184

PROPERTY OWNER
SDUKHDEV SINGH
8385 OPAL DRIVE WESTALND, MI 48185

NOTE:

OWNER AND THE CONTRACTORS ARE THE SOLELY RESPONSIBLE FOR THE PERFORMANCE AND THE EXECUTION OF THE PROJECT AND IT IS THEIR RESPONSIBILITY FOR THE SAFETY OF THE BUILDING STRUCTURE AND THE MATERIALS USED TO RENOVATE AND CONSTRUCT THE PROPOSED FACILITY SHOWN ON THE PLANS

> 09/04/23 REVISE 08/30/23 REVISE 08/22/23 REVISE 08/21/23 REVISE 08/08/23 REVISE 07/25/23 REVISE 04/22/23 OWNER REQUEST

PROJECT NO: MODEL FILE:

DRAWN BY: HAIDER BAJARI CHK'D BY: HAKIM SHAKIR COPYRIGHT

MARK DATE DESCRIPTION

DUPLICATION STRICTLY PROHIBITED WITHOUT THE WRITTEN CONSENT OF ESI.

SHEET TITLE


SOIL EROSION AND SEDIMENTATION CONTROL PLAN

SCALE

NOTED


SHEET No.

SCALE: 1"=30'-0"

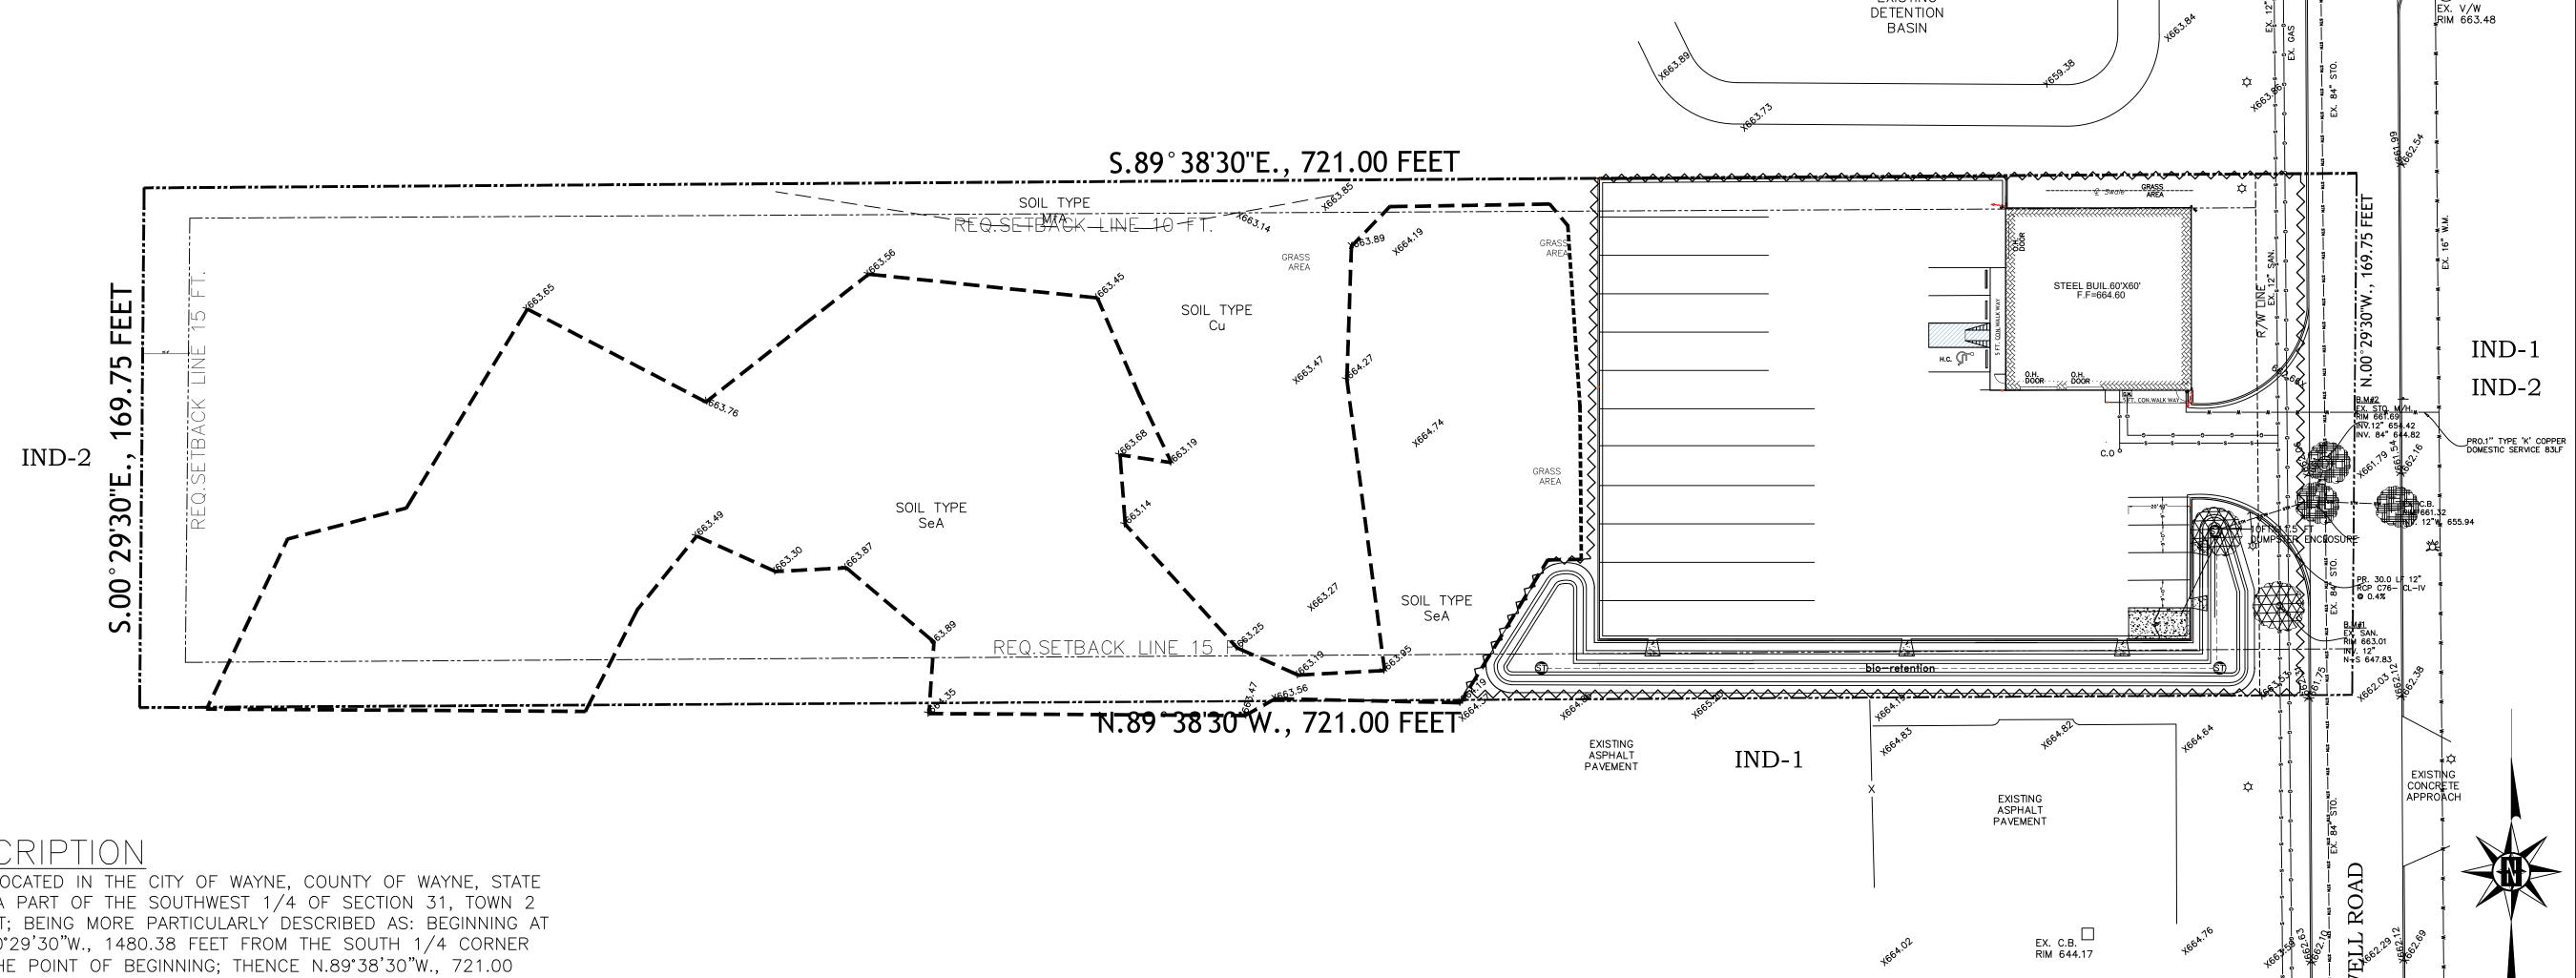


A PARCEL OF LAND LOCATED IN THE CITY OF WAYNE, COUNTY OF WAYNE, STATE OF MICIHGAN, BEING A PART OF THE SOUTHWEST 1/4 OF SECTION 31, TOWN 2 SOUTH, RANGE 9 EAST; BEING MORE PARTICULARLY DESCRIBED AS: BEGINNING AT A POINT DISTANT N.00°29'30"W., 1480.38 FEET FROM THE SOUTH 1/4 CORNER OF SECTION 31 TO THE POINT OF BEGINNING; THENCE N.89°38'30"W., 721.00 FEET; THENCE N.00°29'30"W., 169.75 FEET; THENCE S.89°38'30"E., 721.00 FEET; THENCE S.00°29'30"E., 169.75 FEET TO THE POINT OF BEGINNING. SAID PARCEL CONTAINING 2.81 ACRES.

TAX ID #55-011-99-0010-701.

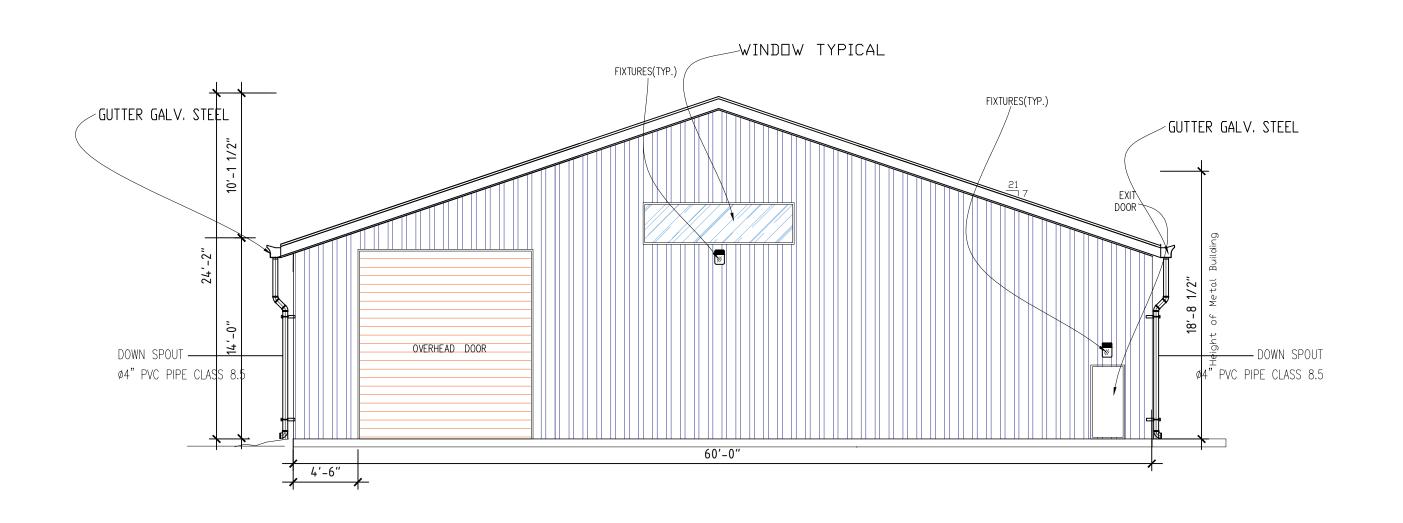

PRO. WEST ELEVATION

SCALE: 1/4" = 1'-0"

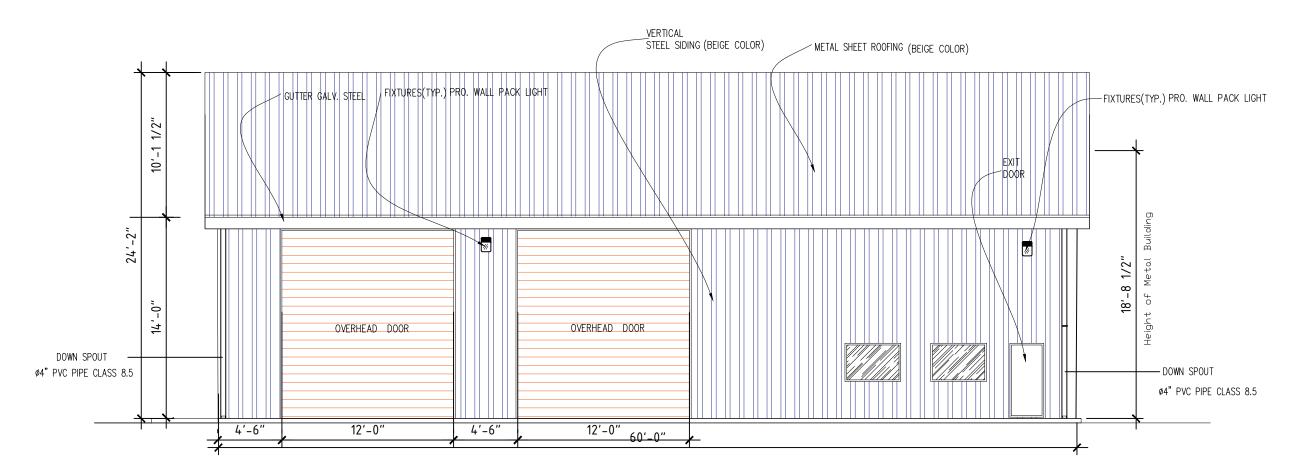

PRO. NORTH ELEVATION

SCALE: 1/4" = 1'-0"

SETTLE SOUND (SINGE COLOR)

NETAL SHEET ROTHING (BODE COLOR)


OUT IN CALLY, STEEL

OUT IN CALLY STEEL

OUT

PRO. SOUTH ELEVATION

SCALE: 1/4" = 1'-0"

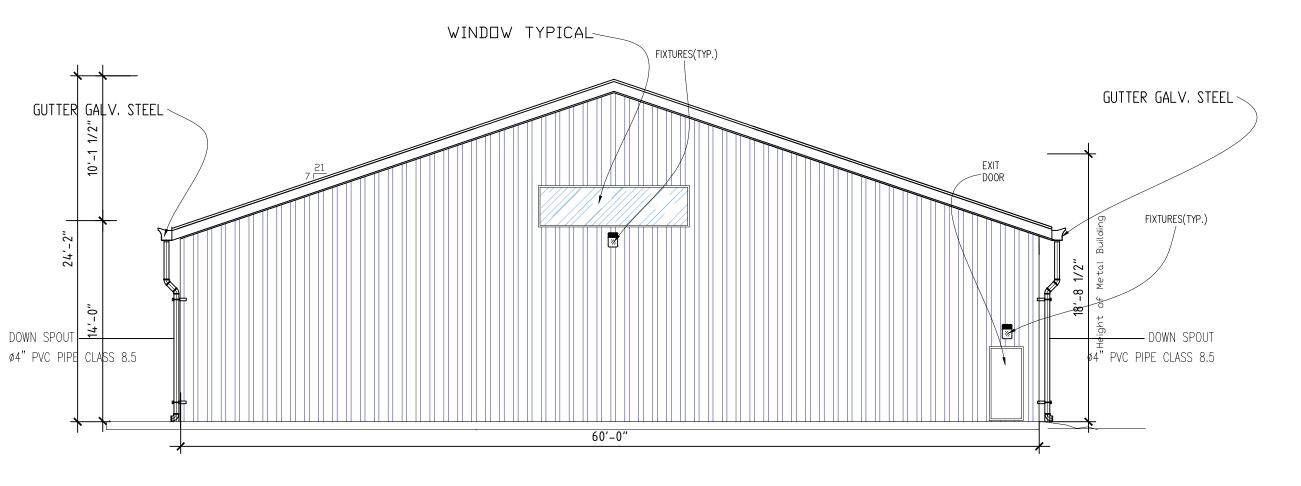

PRO. EAST ELEVATION
SCALE: 1/4" = 1'-0"

THIS PROJECT SHALL ADHERE TO THE FOLLOWING CODES:

2015 MICHIGAN BUILDING CODE
2015 MICHIGAN MECHANICAL CODE
2015 MICHIGAN PLUMBING CODE
2017 NATIONAL ELECTRICAL CODE W/PART 8 RULES
2018 INTERNATIONAL FIRE PREVENTION CODE
90.1.2013 MICHIGAN UNIFORM ENERGY CODE
117.1-2009 ANSI ACCESSIBILITY CODE

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CONSULTANTS



3 WORKING DAYS

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(TOLL FREE)

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G SIDHU TRUCKING

VACANT PROPERTY
PARCEL #55-011-99-0010-701
COGSW ELL ROAD
CITY OF WAYNE ,MI 48184

NOTE:

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04/11/23 OWNER REQUEST

PROJECT NO:

MODEL FILE:

DRAWN BY: HAIDER BAJARI

CHK'D BY: HAKIM SHAKIR
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MARK DATE DESCRIPTION

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SHEET TITLE

ELEVATION PLAN

NOTED


SHEET No.

THIS PROJECT SHALL ADHERE TO THE FOLLOWING CODES: 2015 MICHIGAN BUILDING CODE 2015 MICHIGAN MECHANICAL CODE 2015 MICHIGAN PLUMBING CODE 2017 NATIONAL ELECTRICAL CODE W/PART 8 RULES 2018 INTERNATIONAL FIRE PREVENTION CODE 90.1.2013 MICHIGAN UNIFORM ENERGY CODE 117.1-2009 ANSI ACCESSIBILITY CODE


FIRE NOTES

- 1. A SEPERATE SIGN PERMIT IS REQUIRED
- 2. THE MEANS OF EAGRESS, INCLUDING THE EXIT DISCHARGE, MUST BE ILLUMINATED AT ALL TIMES. THE BUILDING SPACE IS SERVED BY THE OF EAGRESS IS OCCUPIED.
- FIRE EXTINGUISHERS TO BE MOUNTED SO THE THE TRAVEL DISTANCE BETWEEN EXTINGUISHERS DO NOT EXCEED 75 FT (250 FT WITH SPRINKLER SYSTEM. IFC TABLE 906.3 (1).
- 4. THE FLAME SPREAD RATING FOR THE ROOMS MUST HAVE A CLASS B. (76 TO 200). CORRIDORS MUST HAVE A FLAME A FLAME SPREAD RATING MUST BE BETWEEN 0-450. TABLE 803.5 AND 803.1.
- 5. THE EXIT DISCHARGE MUST HAVE ILLUMINATED AND HAVE EMERGENCY POWER SUPPLY. SECTION 1006.1
- 6. THE BOTTOM 10 INCH OF THE GLASS DOORS MUST HAVE A SMOOTH FLUSH PANEL FOR THE ENTIRE WIDTH OF THE DOOR. (ICC/ANSI A 117.1-2009 SECTION 404.2.8.)
- GLAZING WITHIN A 24 INCH ARC OF ENTIRE VERTICAL EDGE OF THE DOOR, IN A CLOSED POSITION, MUST BE SAFETY GLASS. SECTION 2406.3 (3). SECTION 404.2.8.)
- THE EXTERIOR EXIT DISCHARGE LIGHTING SHALL BE EQUIPPED WITH BATTERY BACK UP. THE BACK OF BATTERIES SHALL BE AT MIN. 90 MINUTES RATED AND BE TESTED MONTHLY FOR 30 SEC. AND ANNUALLY FOR 90 MIN. RECORDS SHALL BE MAINTAINED FOR INSPECTION PURPOSES.
- 8. THE EXTERIOR EXIT DISCHARGE LIGHTING SHALL BE EQUIPPED WITH BATTERY BACK UP. THE BACK OF BATTERIES SHALL BE AT MIN. 90 MINUTES RATED AND BE TESTED MONTHLY FOR 30 SEC. AND ANNUALLY FOR 90 MIN. RECORDS SHALL BE MAINTAINED FOR INSPECTION PURPOSES.




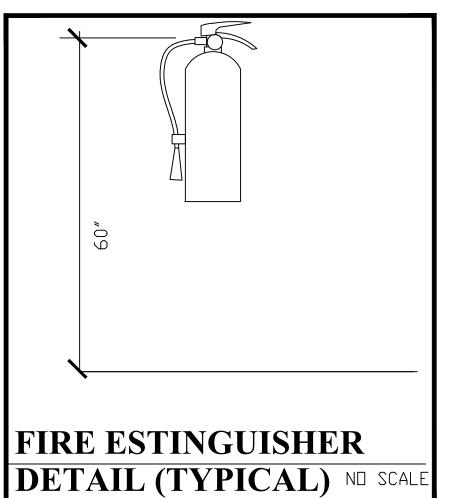


METAL SHEET WALL+ WALL 5/8 "GYP. BD. ON 3-5/8" MTL, STUDS @ 16" O.C TYP.
WALL 5/8 " GYP. BD. ON 3-5/8" MTL, STUDS @ 16" O.C TYP.
NEW METAL SHEET WALL

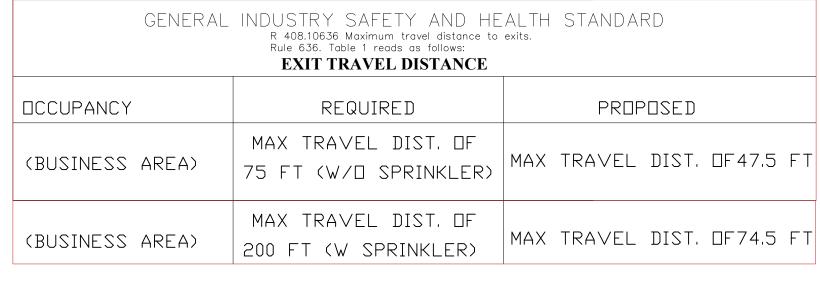

MICHIGAN BUILDING CODE 2015				
USE GROUP:	IND-1 (LIGHT INDUSTRIAL)			
CONSTRUCTION TYPE:	ШВ			
SPRINKLER SYSTEM:	NONE			
PRO. UNIT AREA	3600 SQ FT			
OCCUPANTS: OFFICE AREA	580 SQ FT/100=6			
OCCUPANTS: WORK AREA	3020 SQ FT/100=30			
TOTAL OCCUPANTS:	30+6=36			
OCCUPANT LOAD:	36			
EGRESS REQUIRED	0.2x36= 7.2 IN			
EGRESS PROVIDED	(2) 36 IN= 72 IN			

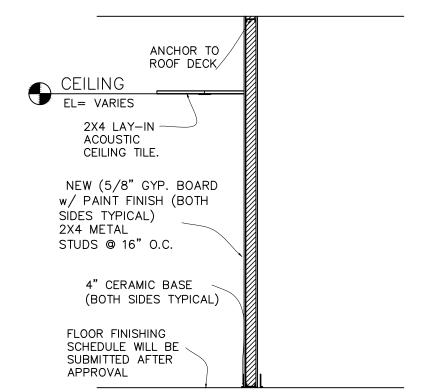

PARTITION SECTION NOT TO SCALE

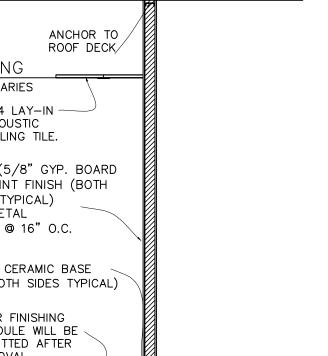

CONSULTANTS

SPECIFICATIONS.

ENGINEERING SERVICS INC., ITS OWNER,

OF CONTRACTORS AND THE OWNER TO PERFORM AND EXECUTE THE PROPOSED PROJECT IN ACCORD WITH THE PLANS AND

THE LATEST CODES AND STANDARD

DESIGNERS, ENGINEERS AND STAFF ARE NOT

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3 WORKING DAYS

G SIDHU TRUCKING

VACANT PROPERTY PARCEL #55-011-99-0010-701

COGSW ELL ROAD CITY OF WAYNE, MI 48184

NOTE:

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04/22/23 OWNER REQUEST

PROJECT NO: MODEL FILE:

DRAWN BY: HAIDER BAJARI CHK'D BY: HAKIM SHAKIR

MARK DATE DESCRIPTION

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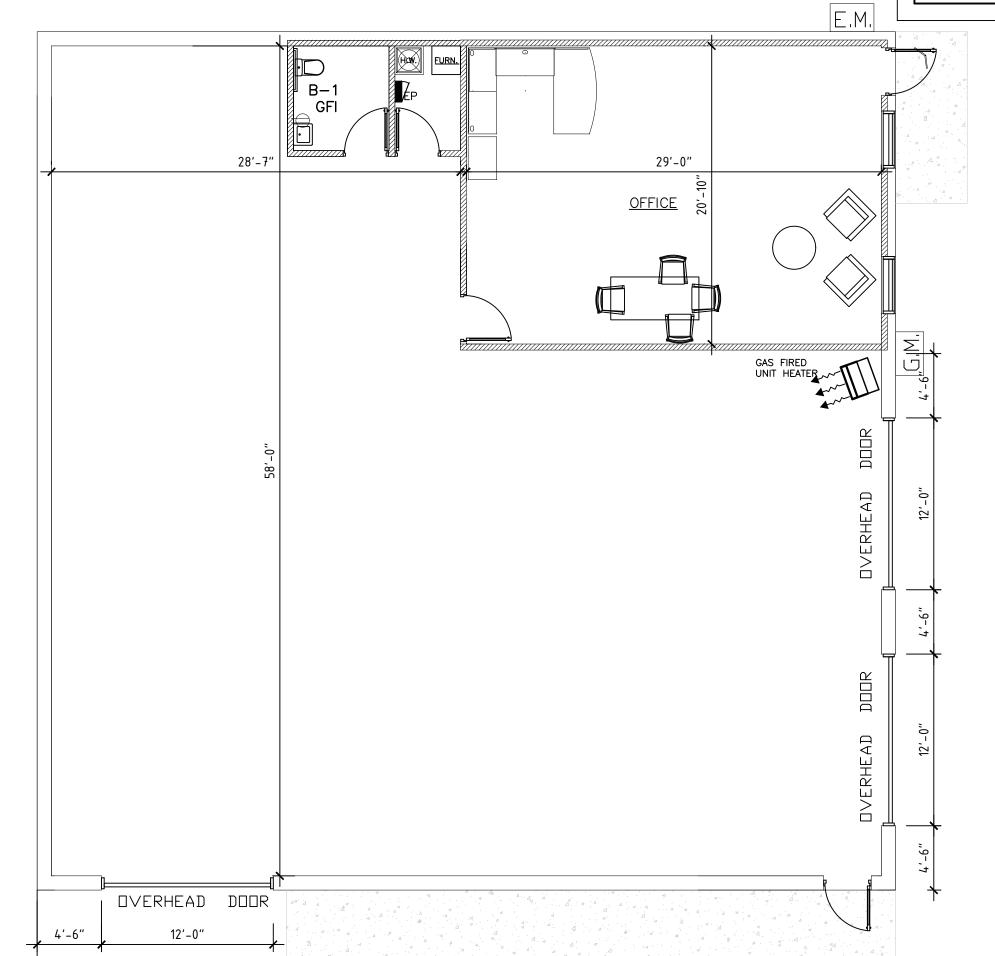
SHEET TITLE

FLOOR PLAN

NOTED


OFFICE AREA WORK AREA OVERHEAD DOOR

> LIFE SAFETY SCALE: 1/4" = 1'-0"



1ST. FLOOR PLAN

SCALE: 1/4" = 1'-0"

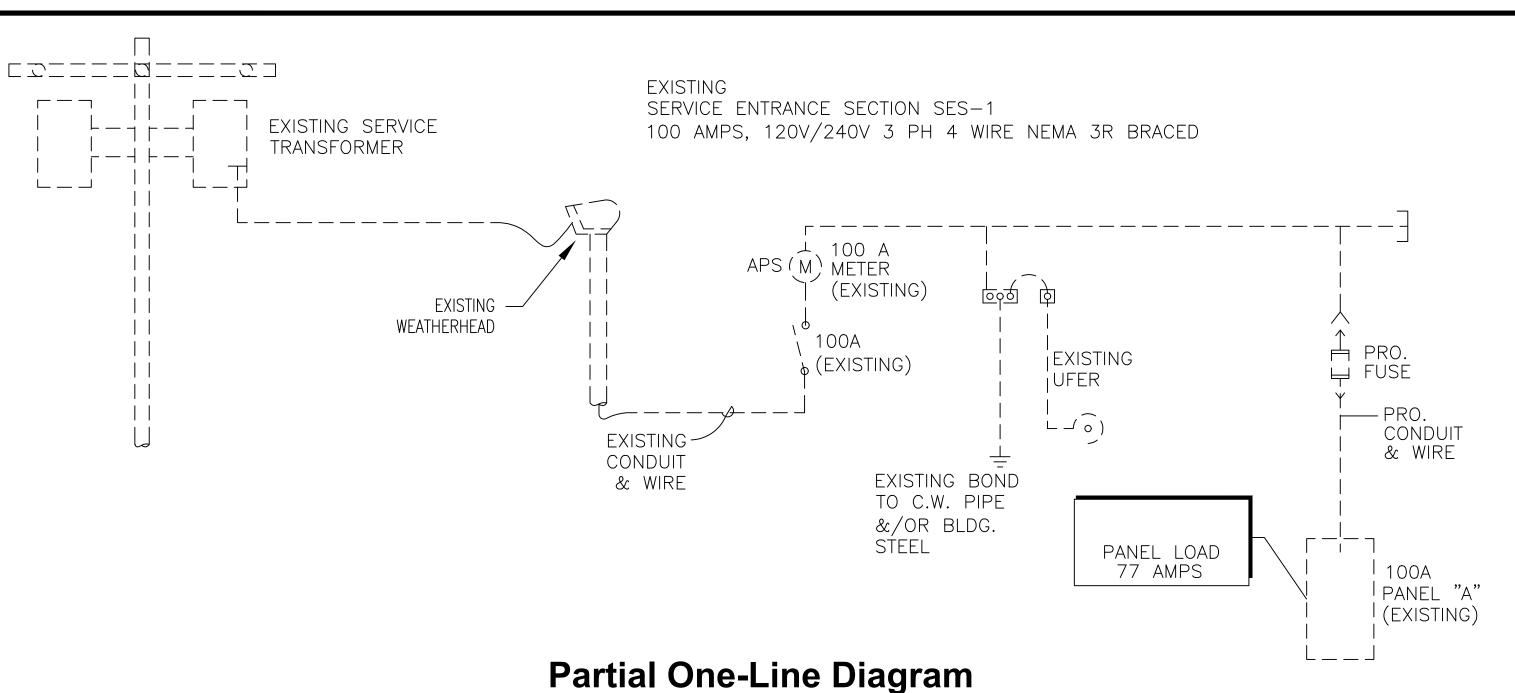

LOCATION VOLTAGE: 120/240/3 PH. AMPS: 100 AMPS UTILITY ROOM WIRE: 4W 30 CIRCUITS PROPOSED PANEL: P-A CIR. A B C CIR. VOLT-AMP c.b. VOLT-AMP DESCRIPTION DESCRIPTION LIGHTING LIGHTING <u> 1</u> 20 20 LIGHTING LIGHTING <u>A</u> 20 800 EMERGENCY LIGHTING 600 20 EXIT SIGN TOTALS | 1600 | 800 | 800 |1760 |1400 | 1400 | (*) LOCK ON DEVICE TOTAL PHASES A = 3360B=2200 C = 2200TOTAL CONNECTED LOAD IN VA: 77,60VA HIGHEST LOAD PER PHASE: 10.410 AMPS; AVAILABLE: 100AMPS NOTES: LIGHTING LOADS THAT RUN CONTINOUSLY FOR THREE HOURS ARE CALCULATED @ 125% OF THE RATED LOADS.

ELECTRICAL ABBREVIATIONS & SYMBOLS				
E.C.	▼	ELECTRICAL CONNECTION — CONDUIT		
D.R.		DUPLEX RECEPTACLE		
S.R.		SINGLE RECEPTACLE		
E.P.		DUPLEX RECEPTACLE/GENERATOR		
HP		HORSE POWER		
K.W.		KILOWATT		
W.		WATT		
AMP		AMPERAGE		
V.		VOLTAGE		
SW	 \(\sigma \)	SWITCH		
JB.		JUNCTION BOX		
	\(\)	INCANDESCENT LIGHT		
		FLUORESCENT LIGHT		
A.F.F.		ABOVE FINISHED FLOOR		
D.F.A.		DROP FROM ABOVE		
RT		RRANCH & CONNECT TO		


SYMBOL LEGEND				
SYMBOL	DESCRIPTION			
	2x4 FLUORESCENT TROFFER T-8, 4-32W ACRYLIC LENS 142W.			
		8 FT. T12 75-WATT LINEAR FLUORESCENT LIGHT FIXTURE		
	FLUORESCENT 2-32W ACRYLIC LENS			
	2'X 2' LAY-IN S/AIR CEILING DIFFUSER			
	2'X 2' LAY-IN R/AIR GRILL			
	EXHAUST FAN			
\otimes	WALL MOUNTED EXIT LIGHT FIXTURE W/ BACK-UP BATTERY ARROW INDICATES EGRESS DIRECTION			
	WALL MOUNTED EMERGENCY LIGHT FIXTURE DUAL VOLT; W/ BACK-UP BATTERY			
	ROUND S/AIR DIFFUSER			
	ROUND R/AIR GRILL			
<u></u>	BUILDING MOUNTED LUMINAIRE, 100W MH, CLEAR LAMP, W/ FULL SHIELD.			

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| BRANCH & CONNECT TO


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SYMBOL	DESCRIPTION				
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<u> </u>	BUILDING MOUNTED LUMINAIRE, 100W MH, CLEAR LAMP, W/ FULL SHIELD.				

NOTE: DASHED LINE INDICATES EXISTING

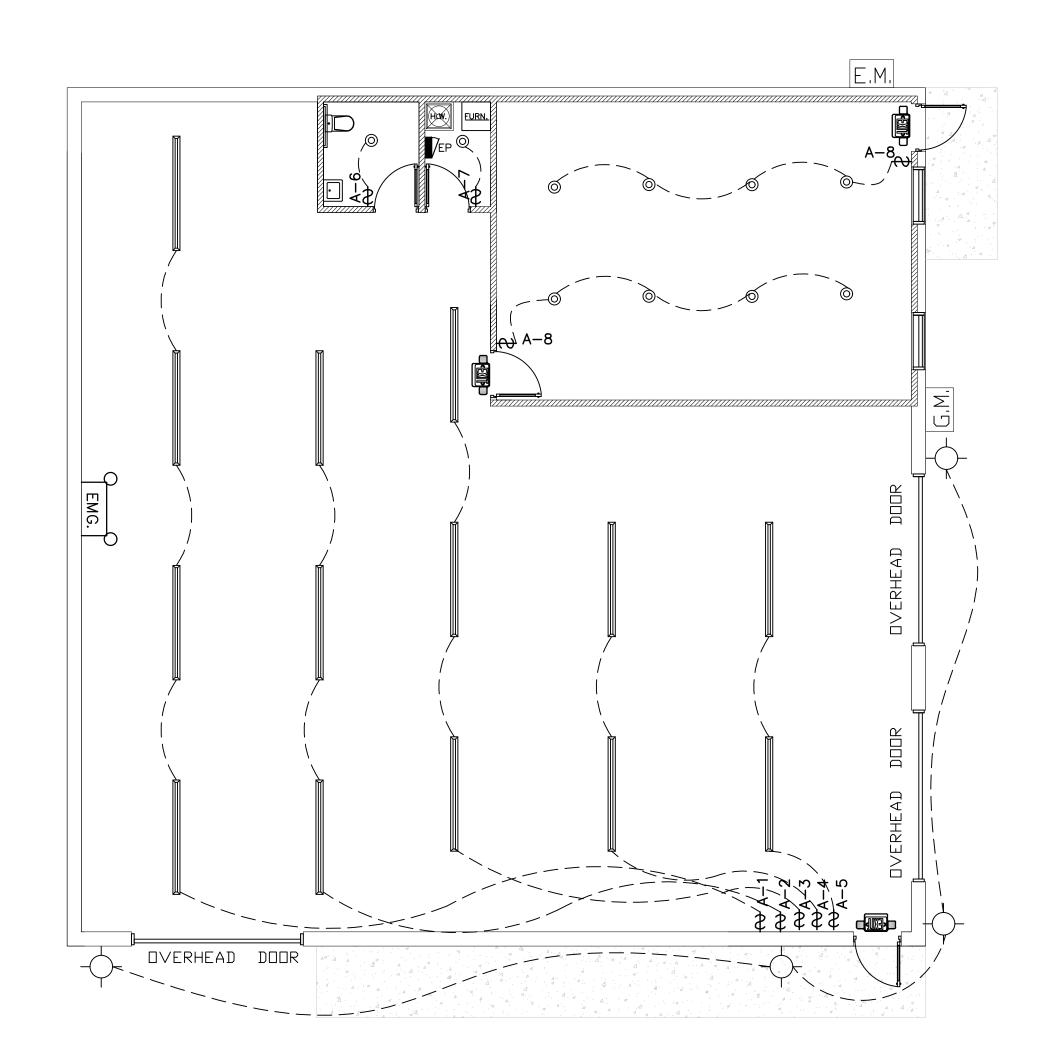


ELECTRICAL LIGHTING PLAN

SCALE: 1/4" = 1'-0"

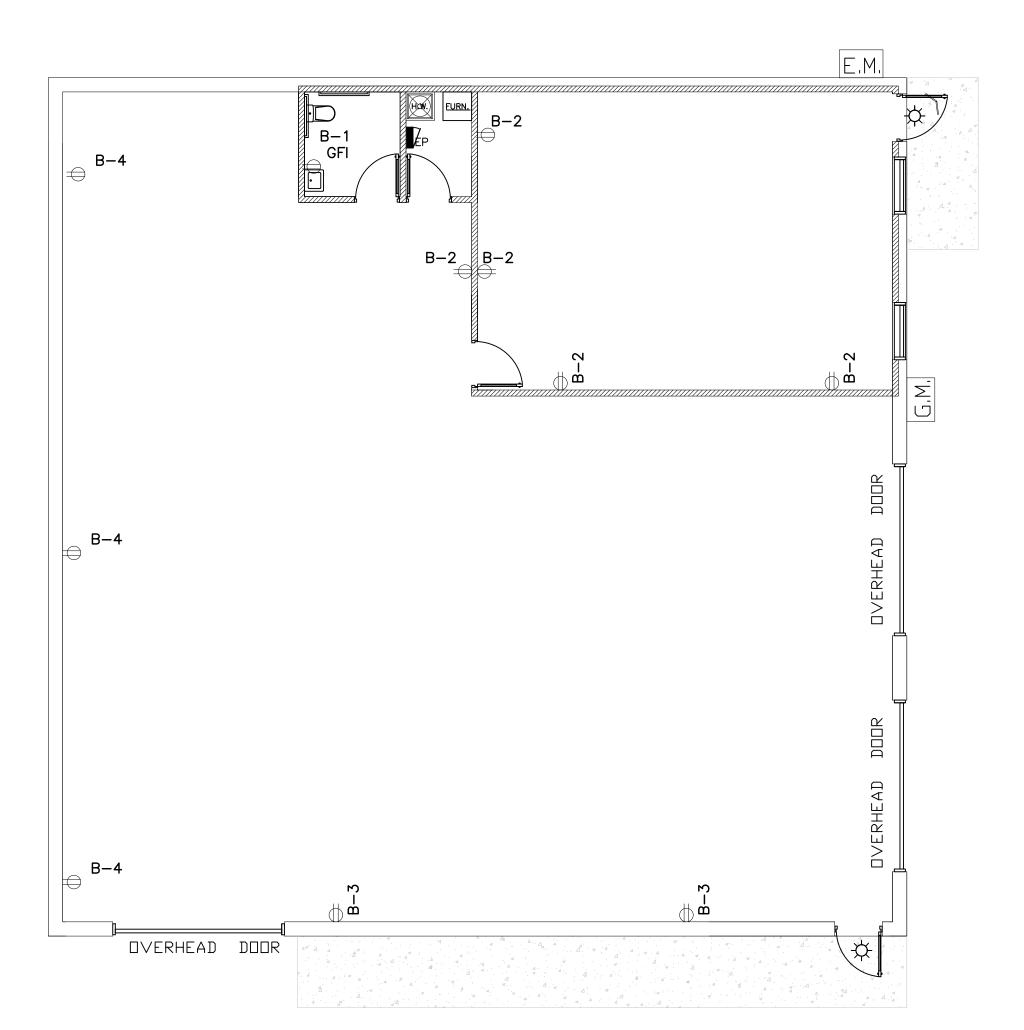

ELECTRICAL POWER PLAN

SCALE: 1/4" = 1'-0"

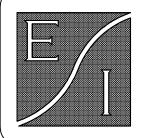

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VACANT PROPERTY PARCEL #55-011-99-0010-701

COGSW ELL ROAD CITY OF WAYNE, MI 48184

NOTE:

BUILDING STRUCTURE AND THE MATERIALS USED TO RENOVATE AND CONSTRUCT THE

PROPOSED FACILITY SHOWN ON THE PLANS

04/22/23 OWNER REQUEST

PROJECT NO: MODEL FILE: DRAWN BY: HAIDER BAJARI CHK'D BY: HAKIM SHAKIR **COPYRIGHT**

MARK DATE DESCRIPTION

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SHEET TITLE

ELECTRICAL PLAN

SCALE

SHEET No.

E-01 NOTED