BM #301 SPIKE IN EAST SIDE OF LIGHT POLE. 107' EAST OF CENTER LINE OF VAN BUREN PARK ROAD AND 777' SOUTH OF CENTER LINE OF SOUTH INTERSTATE 94 SERVICE DR. ELEV. - 703.69

ARROW ON TOP OF HYDRANT. 21' WEST OF NORTHWEST CORNER OF CAR PORT AND 124' SOUTHEAST OF INTER SECTION OF DENTON ROAD AND OLD DENTON ROAD.

ELEV.— 700.22

ARROW ON TOP OF HYDRANT. 35' EAST OF CENTER LINE OF DENTON ROAD AND 70' WEST OF NORTHWEST CORNER OF CAR PORT. ELEV.- 696.45

ARRÖW ON TOP OF HYDRANT 37' WEST OF CENTER LINE OF DENTON ROAD AND 272' NORTHWEST OF INTER SECTION OF DENTON ROAD AND BECKLEY ROAD.

BM #305 SOUTHWEST DIE OF STORM SEWER MANHOLE. 19' NORTHWEST OF INTER SECTION OF CHURCH STREET AND 3RD STREET AND 41' SOUTH WEST OF BUILDING CORNER. ELEV.- 668.75

BM #306 NORTH SIDE OF SANITARY SEWER MANHOLE. 46' NORTHWEST OF INTER SECTION OF ROYS STREET AND CHURCH STREET AND 45' NORTHEAST OF NORTHEAST CORNER OF GAZEBO. ELEV.- 669.71

NORTHEAST SIDE OF MANHOLE. 47' SOUTHEAST OF INTER SECTION OF CHURCH STREET AND 2ND STREET AND 53' SOUTHWEST OF SOUTHWEST CORNER OF BUILDING. ELEV.— 673.56

BM #308 NORTH SIDE OF SANITARY SEWER MANHOLE. 67 SOUTHEAST OF INTER SECTION OF HURON RIVER ROAD AND SOUTH LIBERTY STREET AND 29' SOUTHEAST OF SOUTHEAST CORNER OF VICTORY
PARK SIGN.
ELEV.— 671.44

1/2" IRON ROD WITH CAP. 10' SOUTH OF CENTER LINE OF VAN BUREN PARK ROAD AND 256
NORTHWEST OF NORTHWEST OF BUILDING ELEV.- 698.59

BM #310 RIM ON SANITARY SEWER MANHOLE. 21' SOUTH OF CENTER LINE OF SOUTH INTERSTATE SERVICE ROAD AND 110' WEST OF VAN BUREN PARK ELEV.- 702.67

RIM OF WATER MAIN MANHOLE. 24' SOUTH OF CENTER LINE OF SOUTH INTERSTATE SERVICE ROAD AND 163' NORTHEAST OF NORTH EAST BUILDING CORNER OF DENNY'S. ELEV.- 704.95

BM #312 RIM OF STORM SEWER MANHOLE. 44' EAST OF SOUTH INTERSTATE SERVICE ROAD AND 233' SOUTHWEST OF SOUTHWEST OF BUILDING CORNER OF DENNY'S. ELEV.- 703.85


RIM OF ELECTRIC MANHOLE. 88' SOUTHEAST OF INTER SECTION OF RAWSONVILE ROAD AND SOUTH INTERSTATE SERVICE ROAD AND 182' NORTHWEST OF NORTHWEST BUILDING CORNER OF TIM

RIM OF STORM SEWER MANHOLE. 56' NORTHWEST OF ROWSONVILE ROAD AND SOUTH GROVE STREET AND 76' SOUTHEAST OF SOUTHEAST CORNER OF SPEEDWAY OVERHANG.

CONSTRUCTION PLANS

IRON BELLE TRAIL SECTION D

VAN BUREN TWP, WAYNE COUNTY, MICHIGAN

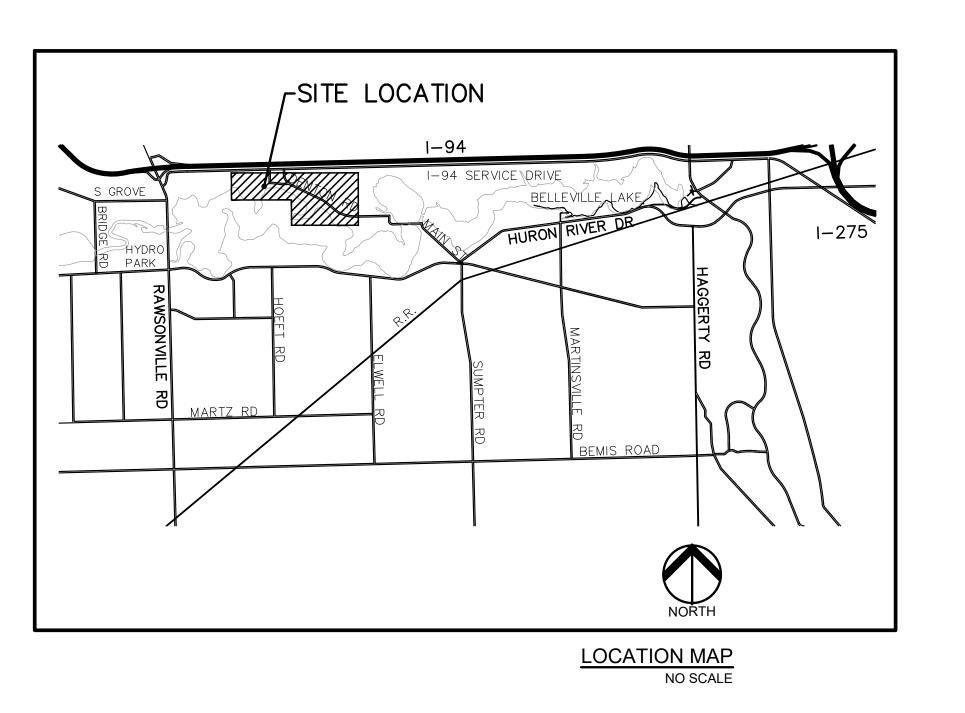

PROJECT DESCRIPTION:

THIS PROJECT IS PART OF THE IRON BELLE TRAIL PROJECT. IT CONSISTS OF CONSTRUCTING APPROXIMATELY .36 AC OF SIDEWALK AND BITUMINOUS PATH ALONG DENTON ROAD AND OLD DENTON ROAD. THIS PROJECT ALSO INCLUDES RESTRIPING DENTON ROAD FOR A BIKE LANE AND SHARROW. THIS PROJECT WILL CONNECT INTO SECTION C (PREVIOUSLY CONSTRUCTED) AT

THIS PROJECT IS LOCATED WITHIN THE EXISTING RIGHT OF WAY OR WITHIN THE ULTIMATE COUNTY RIGHT OF WAY. A LAND USE CHART IS NOT APPROPRIATE.

WAYNE COUNTY REVIEW NO.: R-24-0083

DESIGN TEAM

OWNER/APPLICANT/DEVELOPER CIVIL ENGINEER

VAN BUREN TOWNSHIP 46425 TYLER ROAD VAN BUREN TWP., MI 48111 CONTACT: ELIZABETH RENAUD PHONE: 734-699-8900 EXT 9258 EMAIL: ERENAUD@VANBUREN-MI.ORG

STRUCTURAL ENGINEER LANDSCAPE ARCHITECT

TETRA TECH 7927 NEMCO WAY BRIGHTON, MI 48116 CONTACT: ALAN FLAK, P.E. PHONE: 810-225-8403 EMAIL: ALAN.FLAK@TETRATECH.COM

BRIGHTON, MI 48116

PHONE: 844.813.2949

PEA GROUP 7927 NEMCO WAY, STE. 115 BRIGHTON, MI 48116 CONTACT: JILL RICKARD, PE PHONE: 844.813.2949 EMAIL: JRICKARD@PEAGROUP.COM

CONTACT: JEFF SMITH, PLA, LEED AP


EMAIL: JSMITH@PEAGROUP.COM

7927 NEMCO WAY, STE. 115


Van Buren Department of Public Services

Bill Miner, Water and Sewer Superintendent 46425 Tyler Road Van Buren Twp., MI.48111 PHONE:313-580-0047 EMAIL: wminer@vanburen-mi.org

Kevin Lawrence 46425 Tyler Road Van Buren Twp. MI 4811 PHONE: 734.699.9825 EMAIL: klawrence@vanburen-mi.org

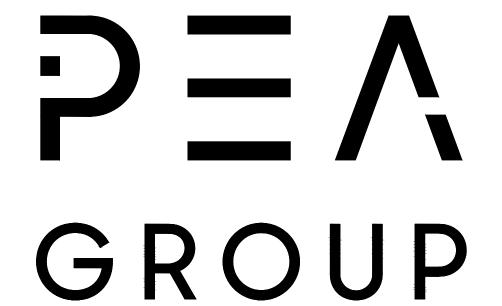



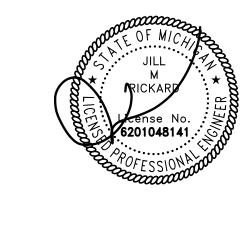

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BRIDGE PLANS (BY OTHERS)

GENERAL PLAN OF STRUCTURE GENERAL PLAN OF STRUCTURE ABUTMENT DETAILS

ABUTMENT DETAILS


MDOT STANDARD PLANS:

LATEST EDITION - (INCLUDED BY REFERENCE). All WORK SHALL CONFORM TO THE MDOT 2020 STANDARD SPECIFICATIONS FOR CONSTRUCTION

<u>TITLE</u>	PLAN NO.
SIDEWALK RAMP AND DETECTABLE WARNING DETAILS	R-28-J
GUARDRAIL TYPES A, B, BD, T, TD, MGS-8, & MGS-8D GUARDRAIL APPROACH TERMINAL TYPE 2M "MSKT"	R-60-J R-62-H
GUARDRAIL DEPARTING TERMINAL TYPES B, T, & MGS	R-66-E

REVISION	IS
DESCRIPTION	DATE
ORIGINAL ISSUE DATE	3/19/2021
WC REVISION	4/16/2024
WC REVISION	5/16/2024

NOT FOR CONSTRUCTION

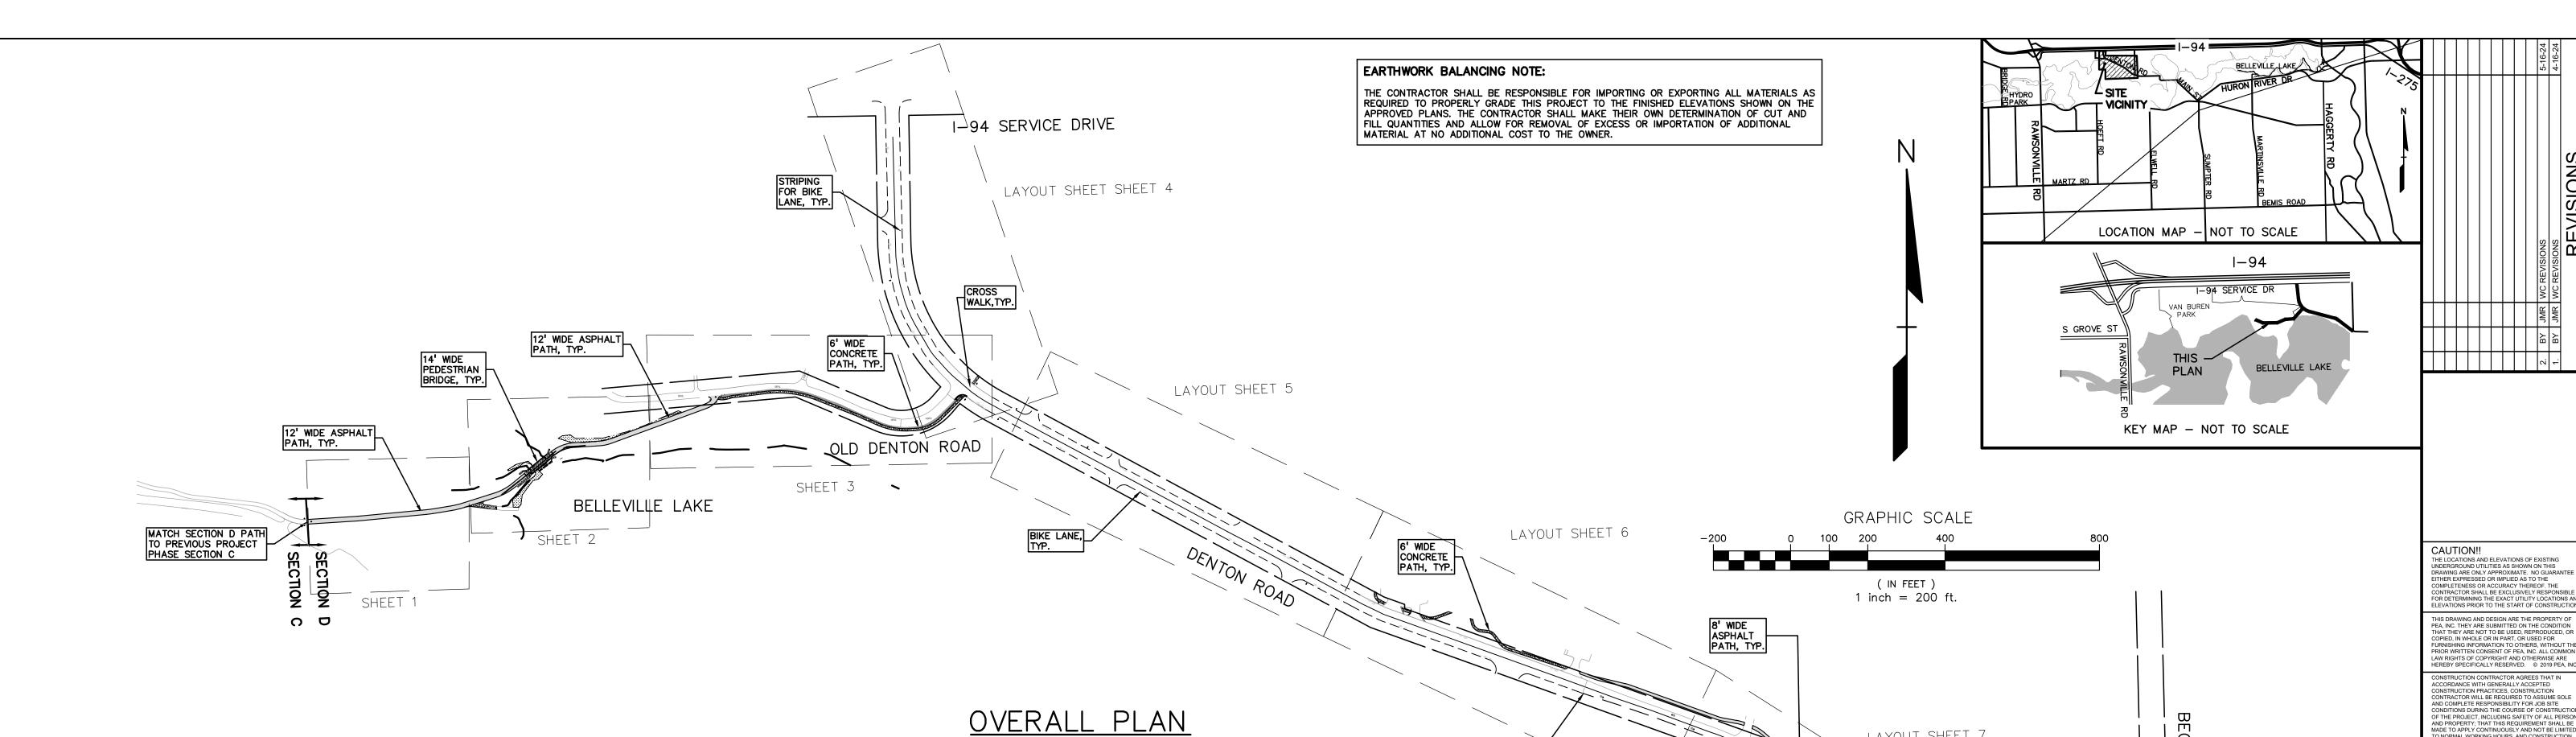

WAYNE COUNTY NOTES:

THESE NOTES APPLY TO ALL CONSTRUCTION ACTIVITIES ON THIS PROJECT

- ALL WORK WITHIN THE WAYNE COUNTY ROAD RIGHT-OF-WAY (ROW) AND DRAIN EASEMENT SHALL BE IN ACCORDANCE WITH THE CURRENT STANDARDS AND GENERAL SPECIFICATIONS, INCLUDING SOIL EROSION AND SEDIMENTATION CONTROL OF THE WAYNE COUNTY DEPARTMENT OF PUBLIC SERVICES, AND MODTO 2012 SPECFICATIONS FOR CONSTRUCTION.
- THESE PLANS ARE NOT VALID WITHOUT ATTACHMENT OF THE WAYNE COUNTY PERMIT SPECIFICATIONS FOR CONSTRUCTION WITHIN THE ROAD ROW, PARKS, DRAIN EASEMENT OR SANITARY SEWER UNDER THE JURISDICTION OF THE WAYNE COUNTY (07/01/93) REVISED 12/15/2004.
- CONTRACTOR SHALL CONTACT MISS DIG AT 811 TO IDENTIFY AND FLAG/MARK THE LOCATIONS OF ALL UNDERGROUND UTILITIES AT THE PROPOSED CONSTRUCTION AREAS PRIOR TO START OF CONSTRUCTION AND SHALL BE RESPONSIBLE FOR DETERMINING THE EXACT LOCATIONS AND ELEVATIONS OF ALL UNDERGROUND UTILITIES AND RESOLVE ANY CONFLICT BETWEEN THE PROPOSED WORK AND THE EXISTING UNDERGROUND OR ABOVE GROUND UTILITIES.
- CONTRACTOR SHALL MAINTAIN 18" MINIMUM VERTICAL CLEARANCE AND 3 FEET MINIMUM HORIZONTAL CLEARANCE BETWEEN THE PROPOSED AND EXISTING UTILITIES. ANY PROPOSED UTILITY PERMITTED TO CROSS UNDER THE ROAD OR DRAIN, MUST BE PLACED A MINIMUM OF 7 FEET BELOW THE LOWEST POINT OF THE ROAD, OR 6 FEET BELOW THE DRAIN BOTTOM, OVERHEAD WIRES/CABLES MUST BE INSTALLED 18 FEET MINIMUM ABOVE THE ROAD CENTERLINE. TO RELOCATE ANY UTILITY WITHIN THE ROAD ROW, THE CONTRACTOR SHALL COORDINATE THE RELOCATION WITH THE UTILITY COMPANY AND AS DIRECTED BY THE WAYNE COUNTY ENGINEER.
- ALL SURVEY MONUMENTS/CORNERS AND BENCH MARKS LOCATED WITHIN THE CONSTRUCTION AREA MUST BE PRESERVED IN ACCORDANCE WITH PUBLIC ACT 74 AS AMENDED (INCLUDING ACT 34, P.A. 2000) AND AS PER WAYNE COUNTY PERMIT RULE 1.5. THE PERMIT HOLDER AND CONTRACTOR SHALL COORDINATE THE WORK WITH A PROFESSIONAL SURVEYOR LICENSED IN THE STATE OF MICHIGAN DURING CONSTRUCTION ACTIVITIES FOR THE PURPOSE OF WITNESSING, PRESERVING REPLACING SURVEY MONUMENTS AND MONUMENT BOXES.
- EXPOSURE OF ANY UTILITIES UNDER THE PAVEMENT WILL NOT BE PERMITTED, UNLESS APPROVED BY THE WAYNE COUNTY ENGINEER. PAVEMENT REMOVAL AND REPLACEMENT SHALL BE PERFORMED PER APPLICABLE WAYNE COUNTY STANDARD DETAILS AND AS DIRECTED BY THE WAYNE COUNTY ENGINEER.
- CONTRACTOR SHALL RESTORE ALL DISTURBED AREAS WITHIN THE WAYNE COUNTY ROAD ROW AND DRAIN EASEMENT WITH 3" TOPSOIL, THM SEED MIX AND MULCH. SLOPES STEEPER THAN 1 ON 3 SHALL BE RESTORED BY PLACING SOD
- 8. ALL BACKFILLS UNDER OR WITHIN 3 FEET OF THE PROPOSED OR EXISTING PAVEMENT, CURB OR SIDEWALK SHALL CONFORM TO THE WAYNE COUNTY TRENCH "B" BACKFILL REQUIREMENTS. TRENCH "A" BACKFILL MAY BE USED WITHIN THE ROAD ROW AREAS UNDER CONDITIONS OTHER THAN THOSE SPECIFIED FOR TRENCH "B".
- CONTRACTOR IS RESPONSIBLE FOR RESTORING OR REPLACING ALL DISTURBED LANDSCAPED AREAS, SPRINKLER SYSTEMS, FENCES, SIGNS, MAIL BOXES, ETC. WITHIN THE WAYNE COUNTY ROAD ROW AND / OR AS DIRECTED BY THE
- 10. CONTRACTOR SHALL MAINTAIN TWO-WAY TRAFFIC AT ALL TIMES OTHERWISE, DETOURING TRAFFIC MUST BE PER APPROVED PLANS, ALL SIGNING AND TRAFFIC CONTROL DEVICES SHALL BE IN ACCORDANCE WITH THE LATEST EDITION
- 11. MAINTAIN A SAFE AND ADEQUATE TRAVEL ROUTE FOR PEDESTRIANS AT ALL TIMES THROUGHOUT THE PROJECT
- 12. TUNNELING, BORING AND JACKING OPERATIONS SHALL BE IN ACCORDANCE WITH THE WAYNE COUNTY SPECIFICATIONS AND DETAILS. BORE PITS SHALL BE PLACED AT MINIMUM 10 FEET FROM THE BACK OF CURB OR EDGE OF PAVEMENT.
- 13. REMOVE ALL ABANDONED CONDUITS FROM THE COUNTY ROADS ROW OR AS DIRECTED BY THE WAYNE COUNTY
- 14. CONTRACTOR SHALL PROVIDE COLD WEATHER PROTECTION FOR ALL PROPOSED CONCRETE WORK (PAVEMENTS, SIDEWALKS, DRIVE APPROACHES, ETC.) AS DIRECTED BY THE WAYNE COUNTY ENGINEER.
- 15. OVERNIGHT VEHICLE PARKING AND STORAGE OF CONSTRUCTION MATERIALS AND EQUIPMENT ARE NOT PERMITTED WITHI THE WAYNE COUNTY ROADS RIGHTS-OF-WAY.
- 16. CONTRACTOR SHOULD OBTAIN A SOIL EROSION AND SEDIMENTATION CONTROL PERMIT FROM THE WAYNE COUNTY DPS. CONTACT THE WAYNE COUNTY SOIL EROSION OFFICE AT (734) 326-5565, OR THE COMMUNITY HAVING JURISDICTION OVER THE SOIL EROSION PERMIT.
- 17. CONTRACTOR SHALL NOTIFY THE WAYNE COUNTY TRAFFIC SIGNAL SHOP AT (734) 955-2154.
- 18. CONTRACTOR SHALL NOTIFY WAYNE COUNTY 72 HOURS PRIOR TO START OF CONSTRUCTION. CONTACT THE PERMIT OFFICE AT (734) 858-2764.

PAVING NOTES:

- IN AREAS WHERE NEW PAVEMENTS ARE BEING CONSTRUCTED, THE TOPSOIL AND SOIL CONTAINING ORGANIC MATTER SHALL BE REMOVED PRIOR TO PAVEMENT CONSTRUCTION.
- REFER TO ARCHITECTURAL PLANS FOR DETAILS OF FROST SLAB AT EXTERIOR BUILDING DOORS.
- CONSTRUCTION TRAFFIC SHOULD BE MINIMIZED ON THE NEW PAVEMENT. IF CONSTRUCTION TRAFFIC IS ANTICIPATED ON THE PAVEMENT STRUCTURE, THE INITIAL LIFT THICKNESS COULD BE INCREASED AND PLACEMENT OF THE FINAL LIFT COULD BE DELAYED UNTIL THE MAJORITY OF THE CONSTRUCTION ACTIVITIES HAVE BEEN COMPLETED. THIS ACTION WILL ALLOW REPAIR OF LOCALIZED FAILURE, IF ANY DOES OCCUR, AS WELL AS REDUCE LOAD DAMAGE ON THE PAVEMENT SYSTEM.
- ALL EXPANSION JOINTS AND CONCRETE PAVEMENT JOINTS TO BE SEALED.
- 5. CONCRETE PAVEMENT JOINTING UNLESS SHOWN OTHERWISE IN THE PLANS OR REQUIRED BY THE AUTHORITY HAVING JURISDICTION; 5.1. WHERE PROPOSED CONCRETE ABUTS A STRUCTURE, PROVIDE A MINIMUM 1/2" EXPANSION JOINT. THE JOINT FILLER BOARD MUST
- BE AT LEAST THE FULL DEPTH OF THE CONCRETE AND HELD DOWN A 1/2" TO ALLOW FOR SEALING. 5.2. WHERE PROPOSED CONCRETE ABUTS EXISTING CONCRETE OR IN BETWEEN POURS OF PROPOSED CONCRETE (CONSTRUCTION JOINT), PROVIDE 5/8" DOWELS EVERY 30" CENTER TO CENTER HALF WAY ALONG THE THICKNESS OF THE PROPOSED PAVEMENT. ALTERNATE DOWELS SIZES AND SPACING MUST BE APPROVED THE ENGINEER PRIOR TO COMMENCING WORK AND VIA THE
- 5.3. WHERE PROPOSED CONCRETE ABUTS EXISTING OR PROPOSED SIDEWALK OR CURBING, PROVIDE A MINIMUM 1/2" EXPANSION JOINT. 5.4. CONTROL, LONGITUDINAL AND/OR TRANSVERSE JOINTS SHALL BE PLACED TO PROVIDE PANELS WITHIN THE PAVEMENT AS SQUARE AS POSSIBLE WITH THE FOLLOWING MAXIMUM SPACING PARAMETERS:
- 5.4.1. 6-INCH THICK CONCRETE PAVEMENT: 12' X 12' 5.4.2. 8-INCH THICK CONCRETE PAVEMENT: 15' X 15'

OR GREATER THAN 8'

- 5.5. IRREGULAR-SHAPED PANELS MAY REQUIRE THE USE OF REINFORCING MESH OR FIBER MESH AS DETERMINED BY THE ENGINEER. THE USE OF MESH MUST BE APPROVED THE ENGINEER PRIOR TO COMMENCING WORK AND VIA THE SUBMITTAL PROCESS. 5.6. IF A JOINT PLAN IS NOT PROVIDED IN THE PLANS, THE CONTRACTOR SHALL SUBMIT ONE TO THE ENGINEER FOR REVIEW PRIOR TO COMMENCING WORK AND VIA THE SUBMITTAL PROCESS.
- CONCRETE CURBING JOINTING UNLESS SHOWN OTHERWISE IN THE PLANS OR REQUIRED BY THE AUTHORITY HAVING JURISDICTION 6.1. JOINTS WHEN ADJACENT TO ASPHALT PAVEMENT
- 6.1.1. PLACE CONTRACTION JOINTS AT 10' INTERVALS 6.1.2. PLACE 1/2" EXPANSION JOINT AT CATCH BASINS, EXISTING AND PROPOSED SIDEWALK OR EXISTING CURBING.
- 6.1.3. PLACE 1" EXPANSION JOINT:
- 6.1.3.1. AT SPRING POINTS OF INTERSECTIONS OR ONE OF THE END OF RADIUS LOCATIONS IN A CURVE 6.1.3.2. AT 400' MAXIMUM INTERVALS ON STRAIGHT RUNS 6.1.3.3. AT THE END OF RADIUS AT OPPOSITE ENDS IN A CURBED LANDSCAPE ISLAND
- 6.2. JOINTS WHEN TIED TO CONCRETE PAVEMENT 6.2.1. PLACE CONTRACTION JOINTS OPPOSITE ALL TRANSVERSE CONTRACTION JOINTS IN PAVEMENT
- 6.2.2. PLACE 1/2" EXPANSION JOINT AT CATCH BASINS, EXISTING AND PROPOSED SIDEWALK OR EXISTING CURBING. 6.2.3. PLACE 1"EXPANSION JOINT OPPOSITE ALL TRANSVERSE EXPANSION JOINTS IN PAVEMENT
- 6.2.4. CURB AND GUTTER AND CONCRETE SHALL BE TIED TOGETHER SIMILAR TO A LONGITUDINAL LANE TIE JOINT (MDOT B1 JOINT) 6.3. IN BETWEEN POURS OF PROPOSED CONCRETE CURBING (CONSTRUCTION JOINT):
- 6.3.1. CARRY THE REBAR CONTINUOUSLY BETWEEN POURS 6.3.2. IF THE REBAR IS NOT LONG ENOUGH TO CARRY CONTINUOUSLY, THEN TIE TWO PIECES OF REBAR PER THE LATEST MDOT
- CONCRETE SIDEWALK JOINTING UNLESS SHOWN OTHERWISE IN THE PLANS OR REQUIRED BY THE AUTHORITY HAVING JURISDICTION 7.1. PLACE TRANSVERSE CONTRACTION JOINTS EQUAL TO THE WIDTH OF THE WALK WHEN WIDTH IS LESS THAN 8' 7.2. PLACE TRANSVERSE AND LONGITUDINAL CONTRACTION JOINTS EQUAL TO 1/2 THE WIDTH OF THE WALK WHEN WIDTH IS EQUAL TO
- 7.3. PLACE 1" EXPANSION JOINT WHERE ABUTTING SIDEWALK RAMP AND/OR RADIUS IN INTERSECTION 7.4. PLACE TRANSVERSE 1/2" EXPANSION JOINT AT MAXIMUM OF 100' SPACING
- 7.5. PLACE 1/2" EXPANSION JOINT WHEN ABUTTING A FIXED STRUCTURE, OTHER PAVEMENT (CONCRETE PAVEMENT AND DRIVE APPROACHES), UTILITY STRUCTURES, LIGHT POLE BASES AND COLUMNS

GENERAL GRADING AND EARTHWORK NOTES:

DELETERIOUS MATERIALS.

BIKE LANE ENDS/ SHARROW BEGINS

- THESE NOTES APPLY TO ALL CONSTRUCTION ACTIVITIES ON THIS PROJECT
- CONTRACTOR SHALL FIELD VERIFY ALL EXISTING TREES AND BRUSH AND REMOVE ALL THAT ARE NECESSARY TO GRADE SITE.
- 2. ALL GRADES ARE TO TOP OF PAVEMENT UNLESS OTHERWISE NOTED.
- THE STAGING OF CONSTRUCTION ACTIVITIES SHALL OCCUR ONLY WITHIN THE SITE BOUNDARIES. ANY CONSTRUCTION ACTIVITIES OUTSIDE OF THE SITE BOUNDARIES SHALL BE AT THE SOLE RESPONSIBILITY AND RISK OF THE CONTRACTOR.
- ALL SOIL EROSION AND SEDIMENTATION CONTROL MEASURES SHALL MEET THE REQUIREMENTS OF THE AUTHORIZED PUBLIC AGENCY OF JURISDICTION. AN EROSION CONTROL PERMIT MUST BE SECURED FROM THE COUNTY PRIOR TO CONSTRUCTION.
- ALL EARTHWORK AND GRADING OPERATIONS SHALL BE PERFORMED IN ACCORDANCE WITH THE SOILS INVESTIGATION AND REPORT.
- REFER TO SOIL EROSION CONTROL PLAN FOR ADDITIONAL SOIL EROSION AND SEDIMENTATION CONTROL MEASURES AND NOTES.
- THE DETENTION BASIN SIDE SLOPES AND ALL SLOPE EXCEEDING 1:4 MUST BE STABILIZED BY
- SODDING OR BY PLACING A MULCH BLANKET PEGGED IN PLACE OVER SEED. . ALL DISTURBED AREAS SHALL BE SEEDED AND MULCHED OR SODDED IN ACCORDANCE WITH THE
- THE CONTRACTOR SHALL NOTE EXISTING UNDERGROUND UTILITIES WITHIN AND ADJACENT TO THE SITE. BACKFILL FOR EXISTING UTILITY TRENCHES SHALL BE EXAMINED CRITICALLY. ANY TRENCHES FOUND TO HAVE SOFT, UNSTABLE OR UNSUITABLE BACKFILL MATERIAL, IN THE OPINION OF THE THIRD PARTY TESTING COMPANY, THAT ARE TO BE WITHIN THE ZONE OF INFLUENCE OF PROPOSED BUILDINGS OR PAVEMENT SHALL BE COMPLETELY EXCAVATED AND BACKFILLED WITH SUITABLE

LANDSCAPE PLANS. PROVIDE A MINIMUM OF 3" OF TOPSOIL IN THESE AREAS UNLESS OTHERWISE

- 10. ON-SITE FILL CAN BE USED IF THE SPECIFIED COMPACTION REQUIREMENTS CAN BE ACHIEVED. IF ON-SITE SOIL IS USED, IT SHOULD BE CLEAN AND FREE OF FROZEN SOIL, ORGANICS, OR OTHER
- THE FINAL SUBGRADE/EXISTING AGGREGATE BASE SHOULD BE THOROUGHLY PROOFROLLED USING A FULLY LOADED TANDEM AXLE TRUCK OR FRONT END LOADER UNDER THE OBSERVATION OF A GEOTECHNICAL/PAVEMENT ENGINEER. LOOSE OR YIELDING AREAS THAT CANNOT BE MECHANICALLY STABILIZED SHOULD BE REINFORCED USING GEOGRIDS OR REMOVED AND REPLACED WITH ENGINEERED FILL OR AS DICTATED BY FIELD CONDITIONS.
- 12. SUBGRADE UNDERCUTTING, INCLUDING BACKFILLING SHALL BE PERFORMED TO REPLACE MATERIALS SUSCEPTIBLE TO FROST HEAVING AND UNSTABLE SOIL CONDITIONS. ANY EXCAVATIONS THAT MAY BE REQUIRED BELOW THE TOPSOIL IN FILL AREAS OR BELOW SUBGRADE IN CUT AREAS WILL BE CLASSIFIED AS SUBGRADE UNDERCUTTING.
- 3. SUBGRADE UNDERCUTTING SHALL BE PERFORMED WHERE NECESSARY AND THE EXCAVATED MATERIAL SHALL BECOME THE PROPERTY OF THE CONTRACTOR. ANY SUBGRADE UNDERCUTTING SHALL BE BACKFILLED AS RECOMMENDED IN THE GEOTECHNICAL ENGINEERING REPORT FOR THE
- 14. ANY SUB-GRADE WATERING REQUIRED TO ACHIEVE REQUIRED DENSITY SHALL BE CONSIDERED INCIDENTAL TO THE JOB.

GENERAL NOTES:

THE CONFLICT MAY BE RESOLVED.

LAYOUT SHEET 7

- THESE NOTES APPLY TO ALL CONSTRUCTION ACTIVITIES ON THIS PROJECT.
- ALL CONSTRUCTION, WORKMANSHIP AND MATERIALS SHALL BE IN ACCORDANCE WITH CURRENT OSHA, MDOT AND MUNICIPALITY STANDARDS AND REGULATIONS.
- THE CONTRACTOR SHALL NOTIFY THE TOWNSHIP ENGINEER AND/OR THE AUTHORITY HAVING JURISDICTION 3 BUSINESS DAYS PRIOR TO THE BEGINNING OF CONSTRUCTION.

RO

LAYOUT SHEET 8

- THE CONTRACTOR SHALL CONTACT THE ENGINEER SHOULD THEY ENCOUNTER ANY DESIGN ISSUES DURING CONSTRUCTION. IF THE CONTRACTOR MAKES DESIGN MODIFICATIONS WITHOUT THE WRITTEN DIRECTION OF
- THE DESIGN ENGINEER, THE CONTRACTOR DOES SO AT HIS OWN RISK. ALL NECESSARY PERMITS, TESTING, BONDS AND INSURANCES ETC., SHALL BE PAID FOR BY THE

CONTRACTOR. THE OWNER SHALL PAY FOR ALL TOWNSHIP INSPECTION FEES.

- THE CONTRACTOR SHALL NOTIFY THE APPROPRIATE 811/ONE CALL UTILITY LOCATING CENTER, THE CITY ENGINEER AND/OR THE AUTHORITY HAVING JURISDICTION 3 BUSINESS DAYS PRIOR TO THE BEGINNING OF CONSTRUCTION. IF NO NOTIFICATION IS GIVEN AND DAMAGE RESULTS, SAID DAMAGE WILL BE REPAIRED AT SOLE EXPENSE OF THE CONTRACTOR. IF EXISTING UTILITY LINES ARE ENCOUNTERED THAT CONFLICT IN LOCATION WITH NEW CONSTRUCTION, THE CONTRACTOR SHALL NOTIFY THE DESIGN ENGINEER SO THAT
- CONTRACTOR SHALL VERIFY THAT THE PLANS AND SPECIFICATIONS ARE THE VERY LATEST PLANS AND SPECIFICATIONS AND FURTHERMORE, VERIFY THAT THESE PLANS AND SPECIFICATIONS HAVE BEEN APPROVED. ALL ITEMS CONSTRUCTED BY THE CONTRACTOR PRIOR TO RECEIVING FINAL APPROVAL, HAVING TO BE ADJUSTED OR RE-DONE, SHALL BE AT THE CONTRACTORS EXPENSE. SHOULD THE CONTRACTOR ENCOUNTER A CONFLICT BETWEEN THESE PLANS AND/OR SPECIFICATIONS, THEY SHALL SEEK CLARIFICATION IN WRITING FROM THE ENGINEER BEFORE COMMENCEMENT OF CONSTRUCTION. FAILURE TO DO SO SHALL BE AT SOLE EXPENSE TO THE CONTRACTOR.
- ANY WORK WITHIN THE STREET OR HIGHWAY RIGHTS-OF-WAY SHALL BE PERFORMED IN ACCORDANCE WITH THE REQUIREMENTS OF THE AGENCIES HAVING JURISDICTION AND SHALL NOT BEGIN UNTIL ALL NECESSARY PERMITS HAVE BEEN ISSUED FOR THE WORK.
- ALL PROPERTIES OR FACILITIES IN THE SURROUNDING AREAS, PUBLIC OR PRIVATE, DESTROYED OR OTHERWISE DISTURBED DUE TO CONSTRUCTION, SHALL BE REPLACED AND/OR RESTORED TO THE ORIGINAL CONDITION BY THE CONTRACTOR.
- THE CONTRACTOR SHALL PROVIDE ALL NECESSARY BARRICADING, SIGNAGE, LIGHTS AND TRAFFIC CONTROL DEVICES TO PROTECT THE WORK AND SAFELY MAINTAIN TRAFFIC IN ACCORDANCE WITH LOCAL REQUIREMENTS AND THE MANUAL OF UNIFORM TRAFFIC CONTROL DEVICES (LATEST EDITION). THE DESIGN ENGINEER, OWNER, TOWNSHIP AND STATE SHALL NOT BE HELD LIABLE FOR ANY CLAIMS RESULTING FROM ACCIDENTS OR DAMAGES CAUSED BY THE CONTRACTOR'S FAILURE TO COMPLY WITH TRAFFIC AND PUBLIC SAFETY REGULATIONS DURING THE CONSTRUCTION PERIOD.
- 10. THE USE OF CRUSHED CONCRETE IS PROHIBITED ON THE PROJECT WITHIN 100 FEET OF ANY WATER COURSE (STREAM, RIVER, COUNTY DRAIN, ETC.) AND LAKE, REGARDLESS OF THE APPLICATION OR LOCATION OF THE WATER COURSE OR LAKE RÉLATIVE TO THE PROJECT LIMITS.
- 11. IT SHALL BE THE RESPONSIBILITY OF THE CONTRACTOR TO ADJUST THE TOP OF ALL EXISTING AND PROPOSED STRUCTURES (MANHOLES, CATCH BASINS, INLETS, GATE WELLS ETC.) WITHIN GRADED AND /OR PAVED AREAS TO FINAL GRADE SHOWN ON THE PLANS. ALL SUCH ADJUSTMENTS SHALL BE INCIDENTAL TO THE JOB AND WILL NOT BE PAID FOR SEPARATELY.

NOT FOR CONSTRUCTION

XREF: S:PROJECTS\2019\2019—369 VAN BUREN IBT\DWG\SITE PLAN\19—369 VB PARKWAY PLANS\X—SURF D—19369.DWG XREF: S:PROJECTS\2019\2019-369 VAN BUREN IBT\DWG\19369-TOPOBASE.DWG XREF: S:PROJECTS\2019\2019-369 VAN BUREN IBT\DWG\SITE PLAN\19-369 VB PARKWAY PLANS\X-BASE D-19369.DWG
XREF: S:PROJECTS\2019\2019-369\DWG\SITE PLAN\19-369 VB PARKWAY PLANS\X-TBLK-19369.DWG

CONSTRUCTION CONTRACTION AGREES THAT IN ACCORDANCE WITH GENERALLY ACCEPTED CONSTRUCTION PRACTICES, CONSTRUCTION CONTRACTOR WILL BE REQUIRED TO ASSUME SOLE AND COMPLETE RESPONSIBILITY FOR JOB SITE CONDITIONS DURING THE COURSE OF CONSTRUCTI OF THE PROJECT, INCLUDING SAFETY OF ALL PERSO AND PROPERTY; THAT THIS REQUIREMENT SHALL BE AND PROPERTY; THAT I HIS REQUIREMENT SHALL E MADE TO APPLY CONTINUOUSLY AND NOT BE LITT TO NORMAL WORKING HOURS, AND CONSTRUCTIOI CONTRACTOR FURTHER AGREES TO DEFEND, INDEMNIFY AND HOLD DESIGN PROFESSIONAL HARMLESS FROM ANY AND ALL LIABILITY, REAL OR ALLEGED, IN CONNECTION WITH THE PERFORMANCI OF WORK ON THIS PROJECT EXCEPTING LIABILITY ARISING FROM THE SOLE NEGLIGENCE OF THE DESI PROJECTS WALLED THE SOLE NEGLIGENCE OF THE DESI PROJECTS WALL 3 FULL WORKING DAYS

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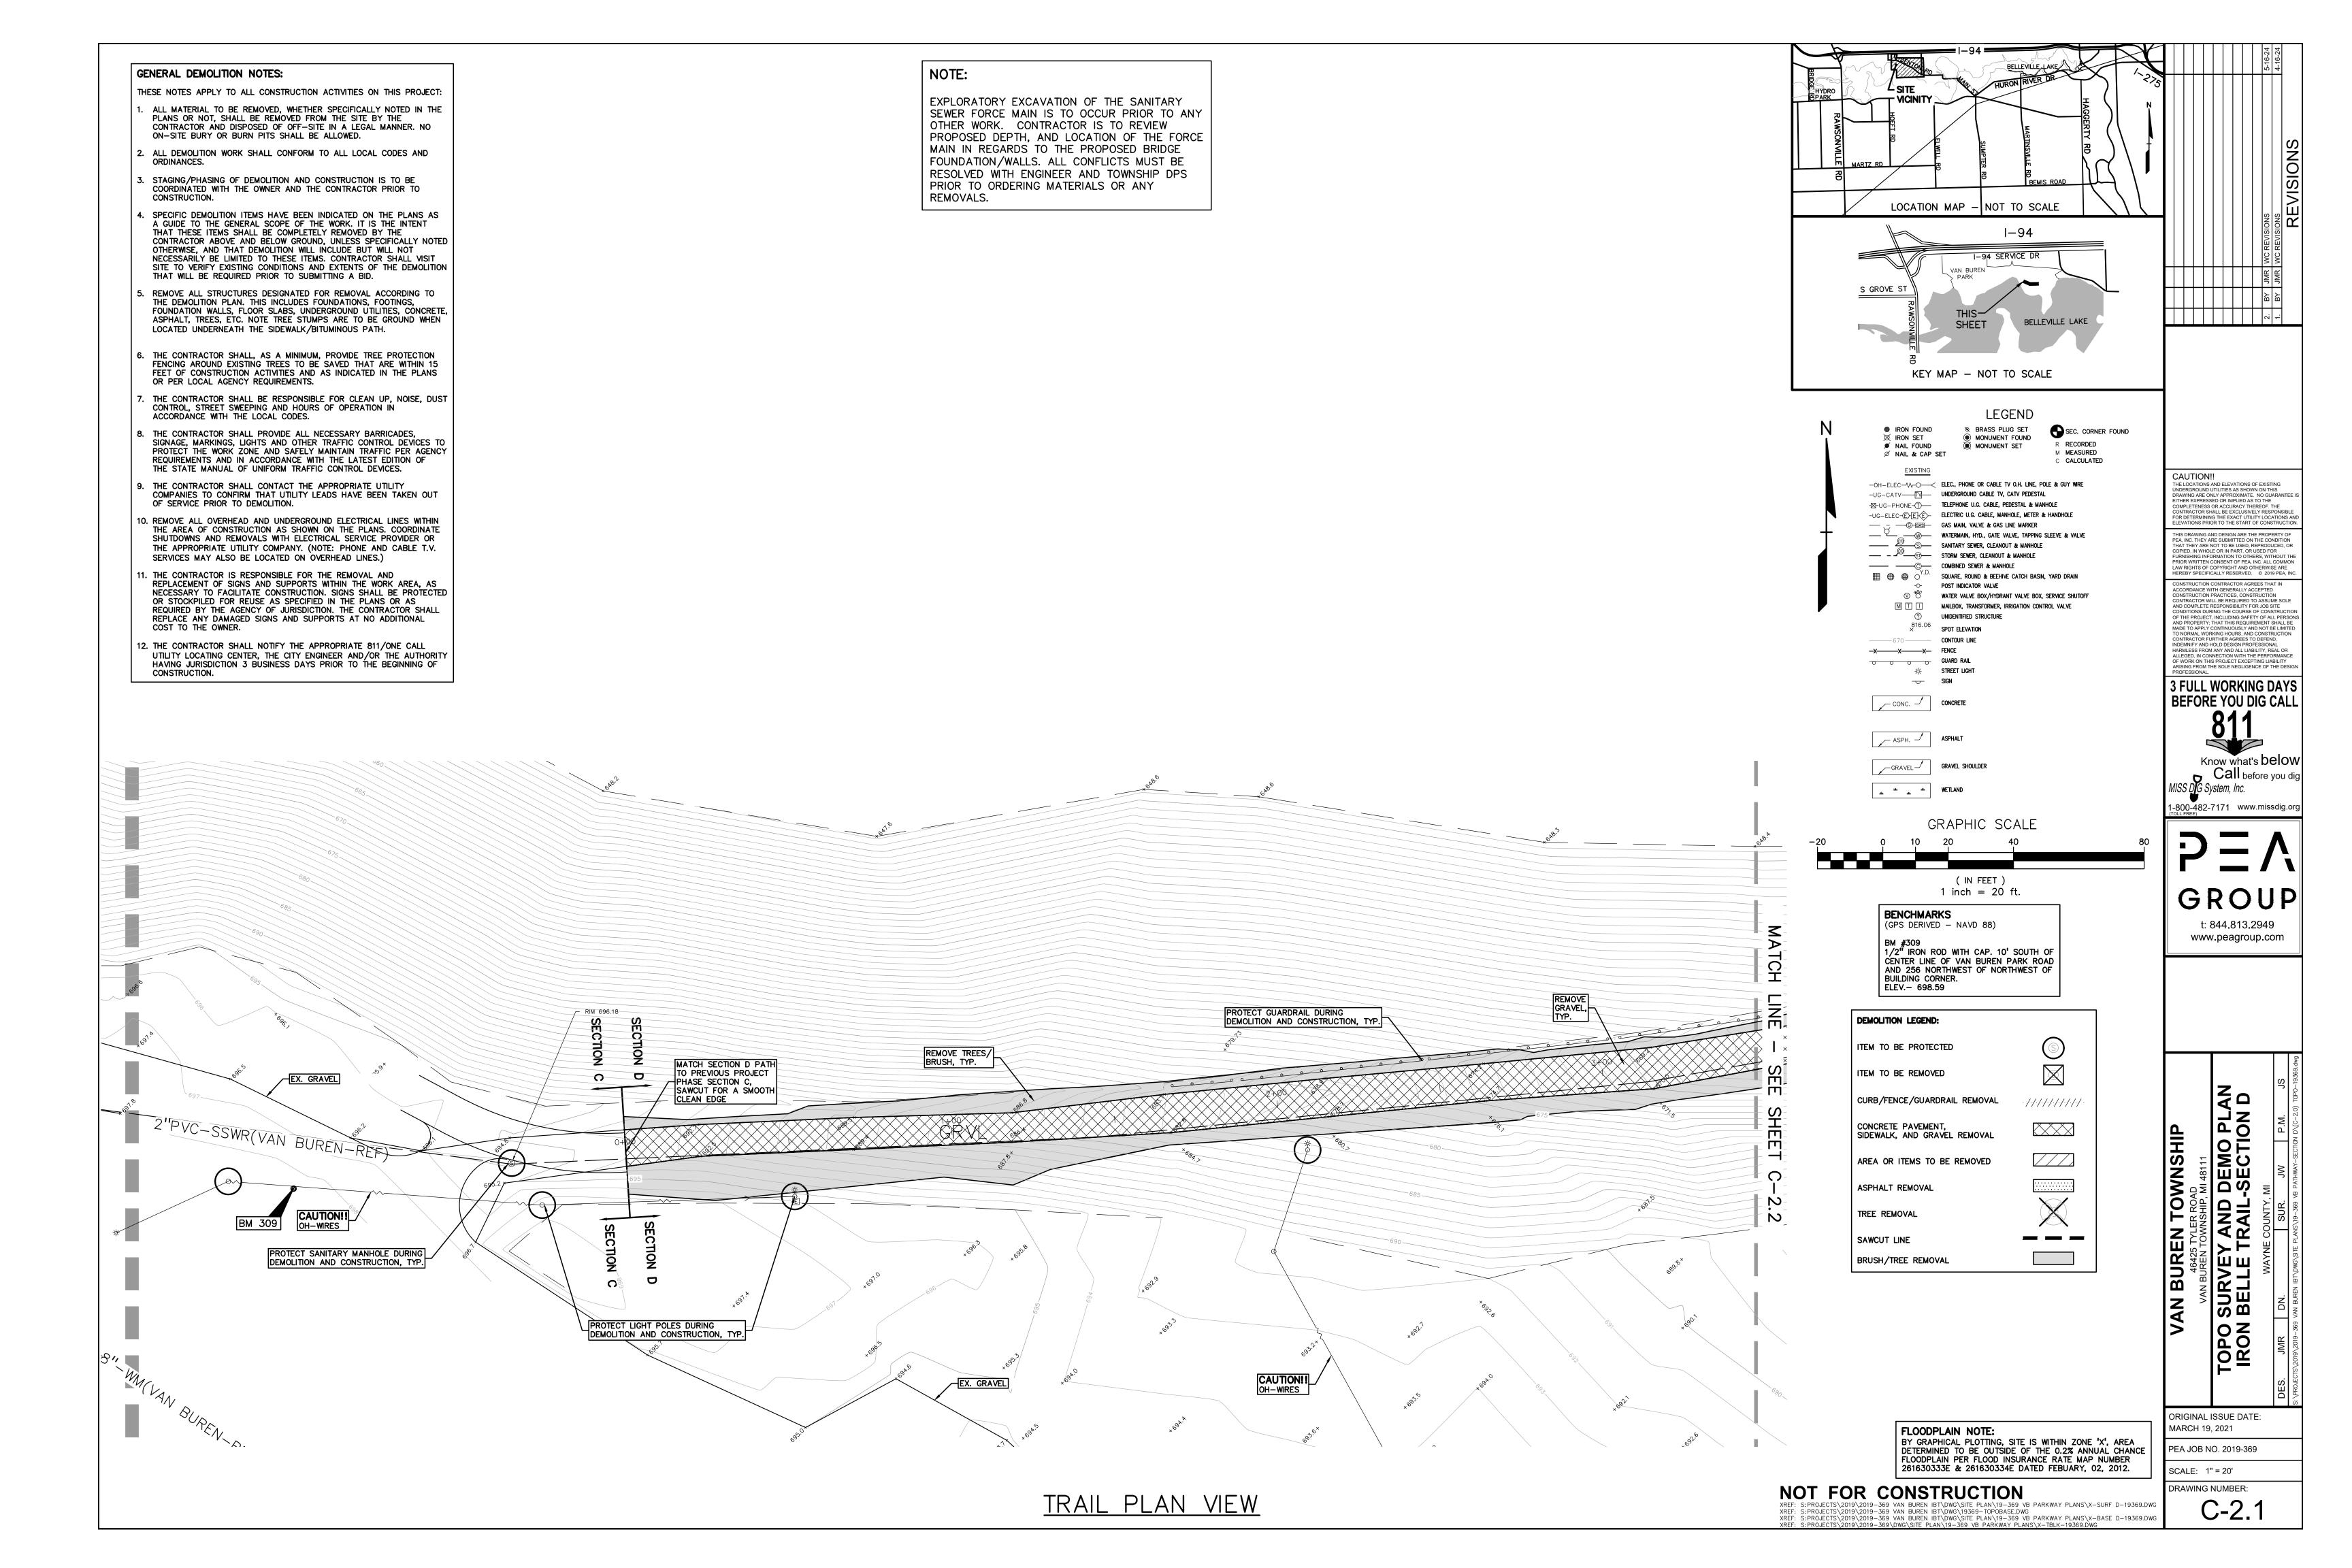
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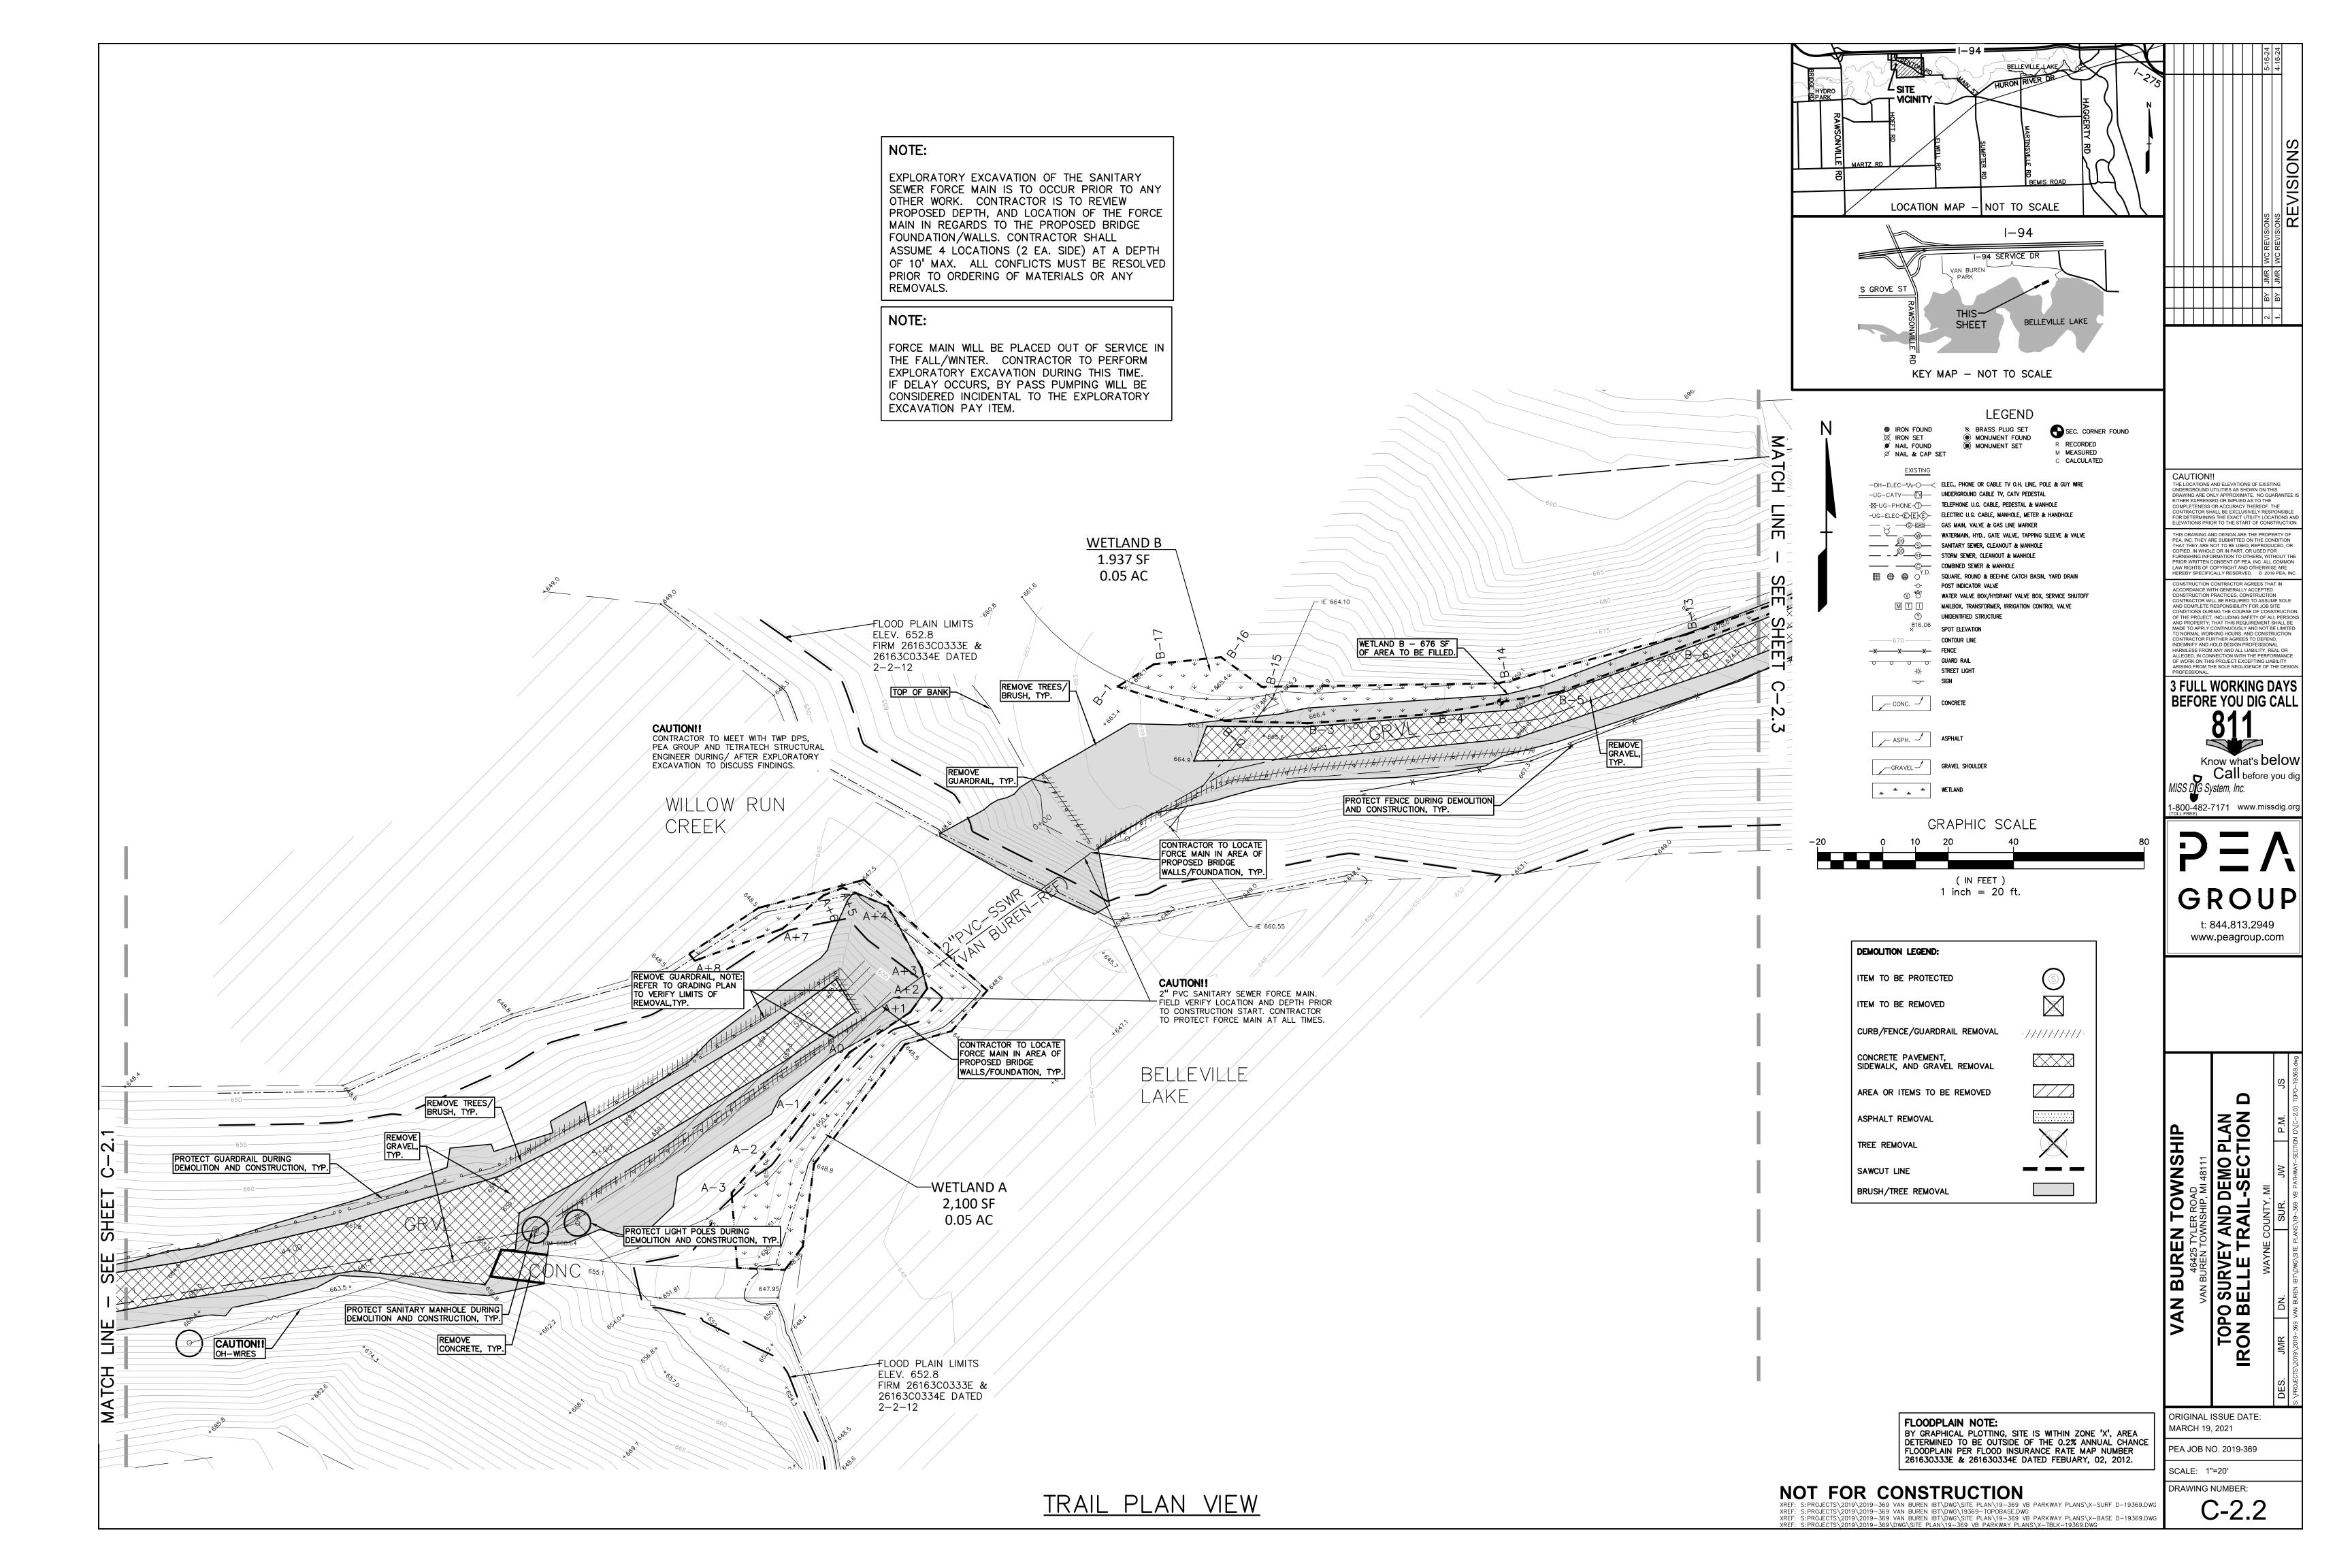
MARCH 19, 2021


PEA JOB NO. 2019-369


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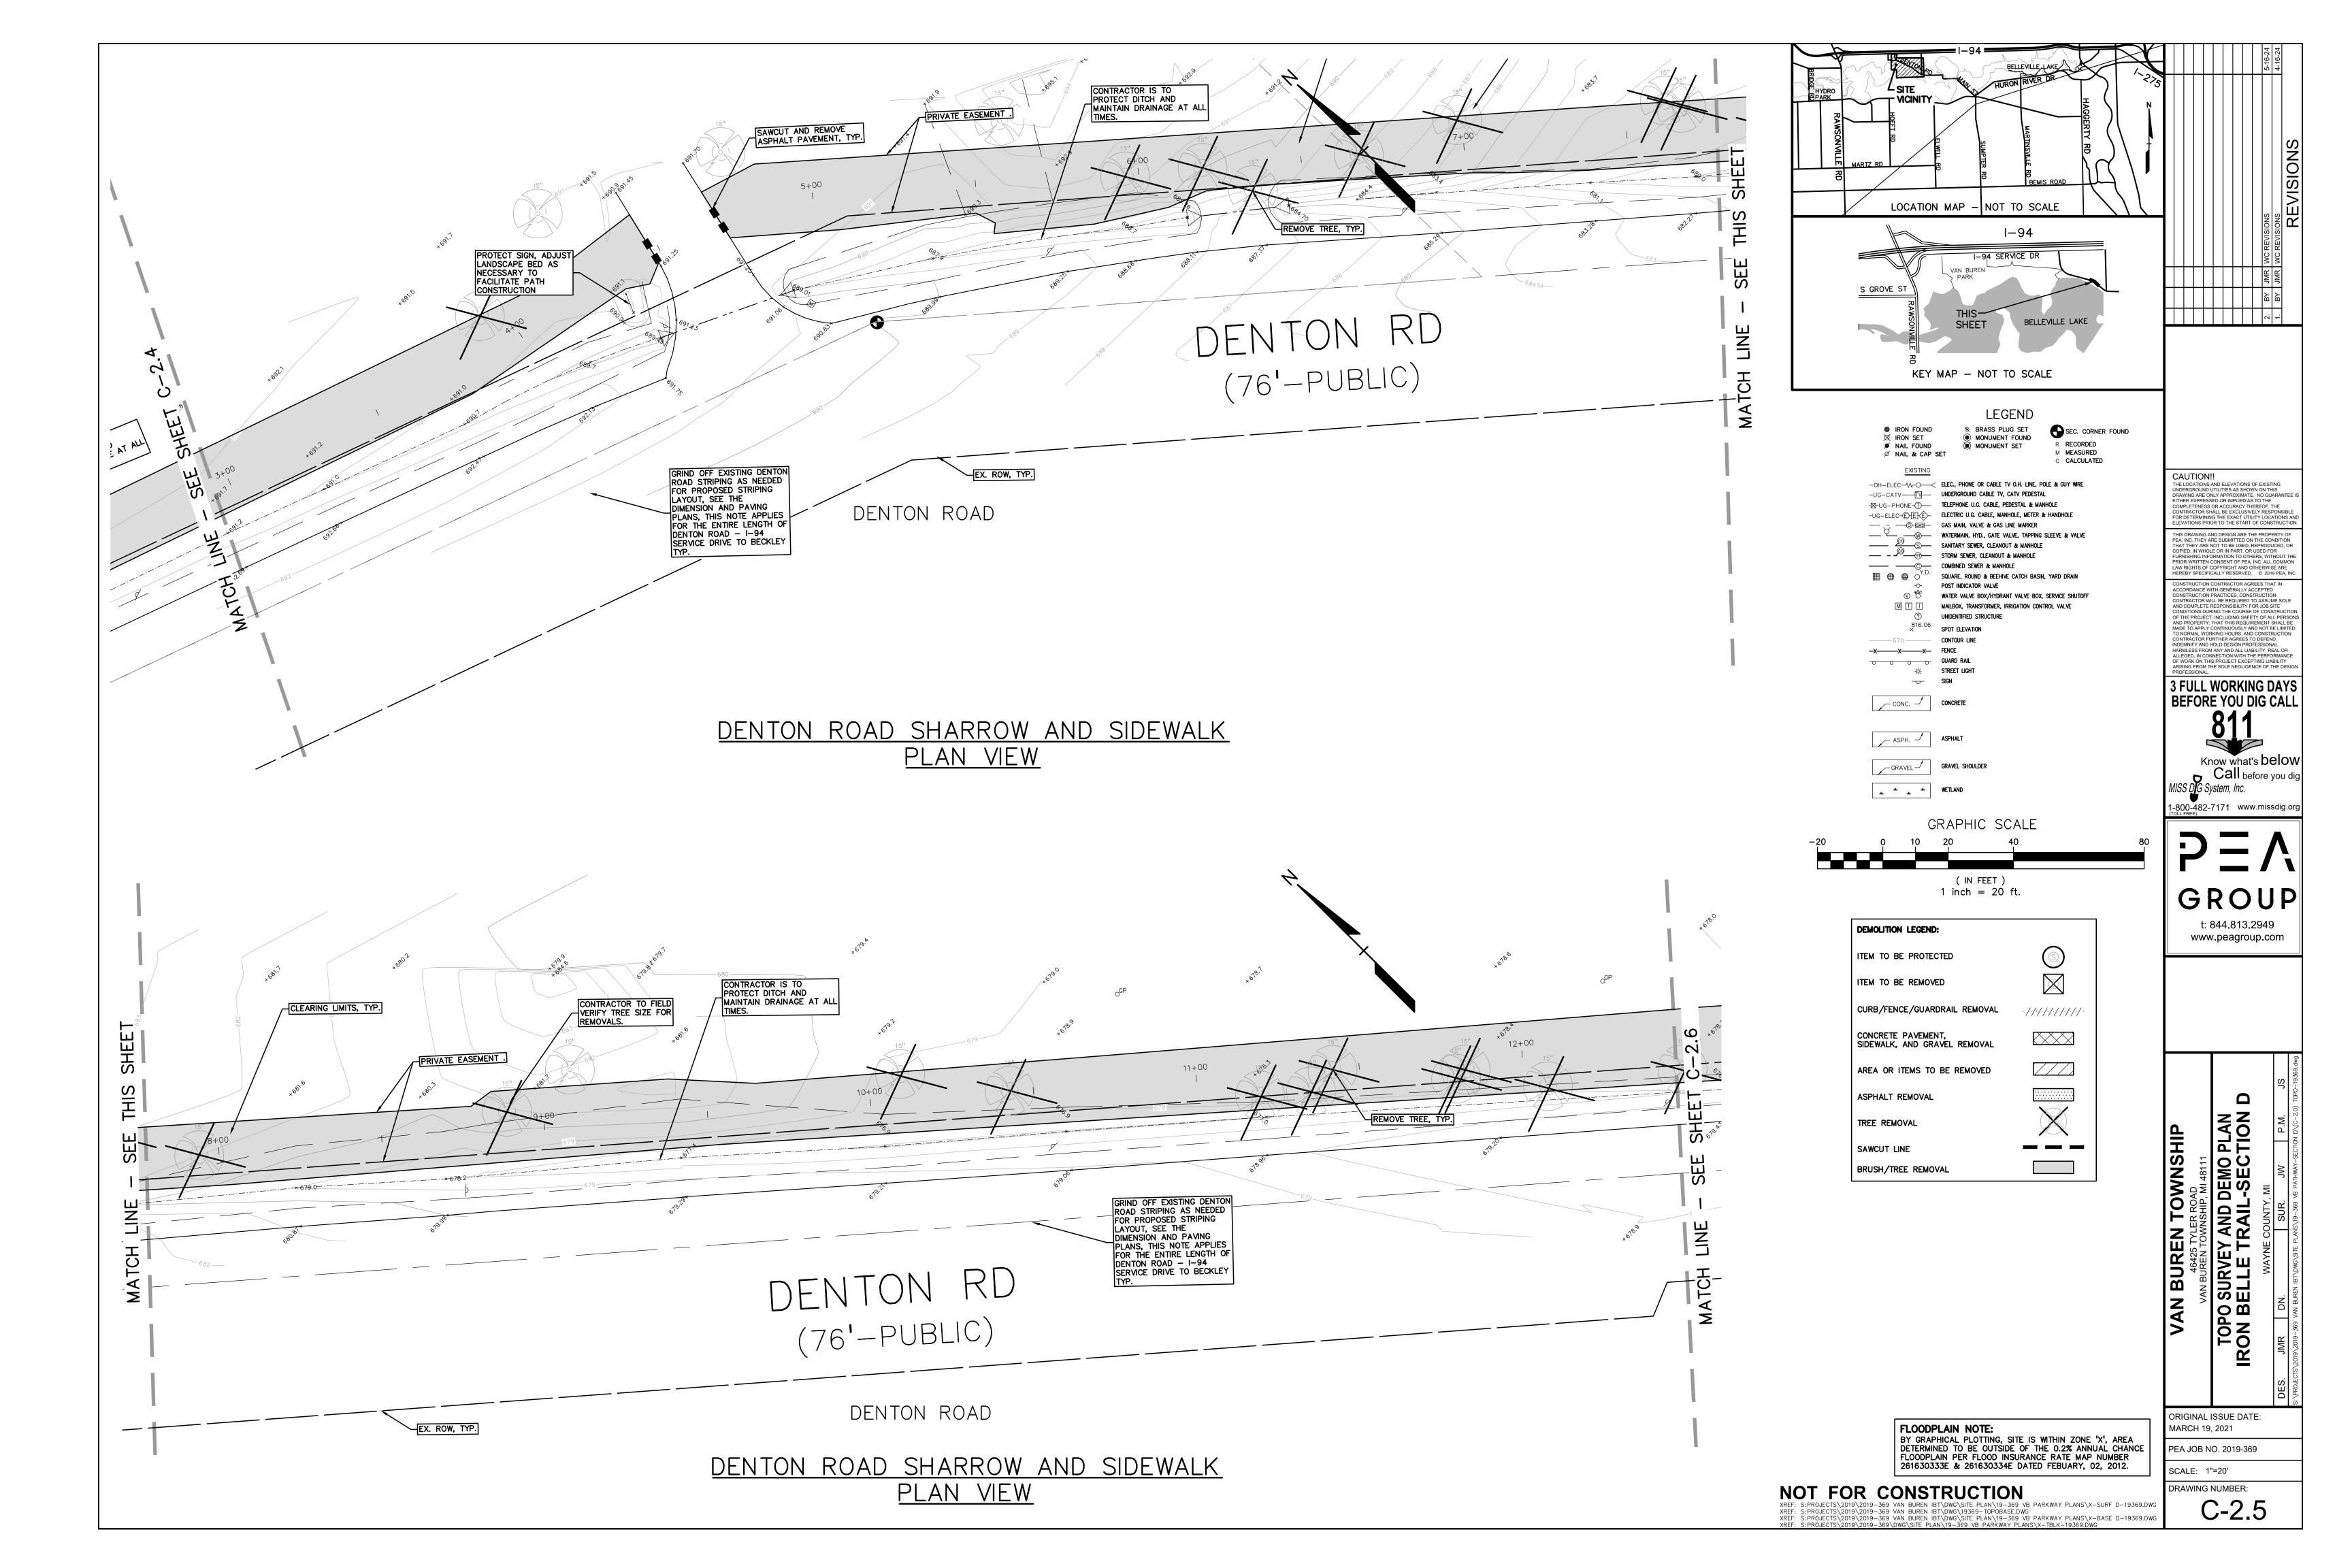
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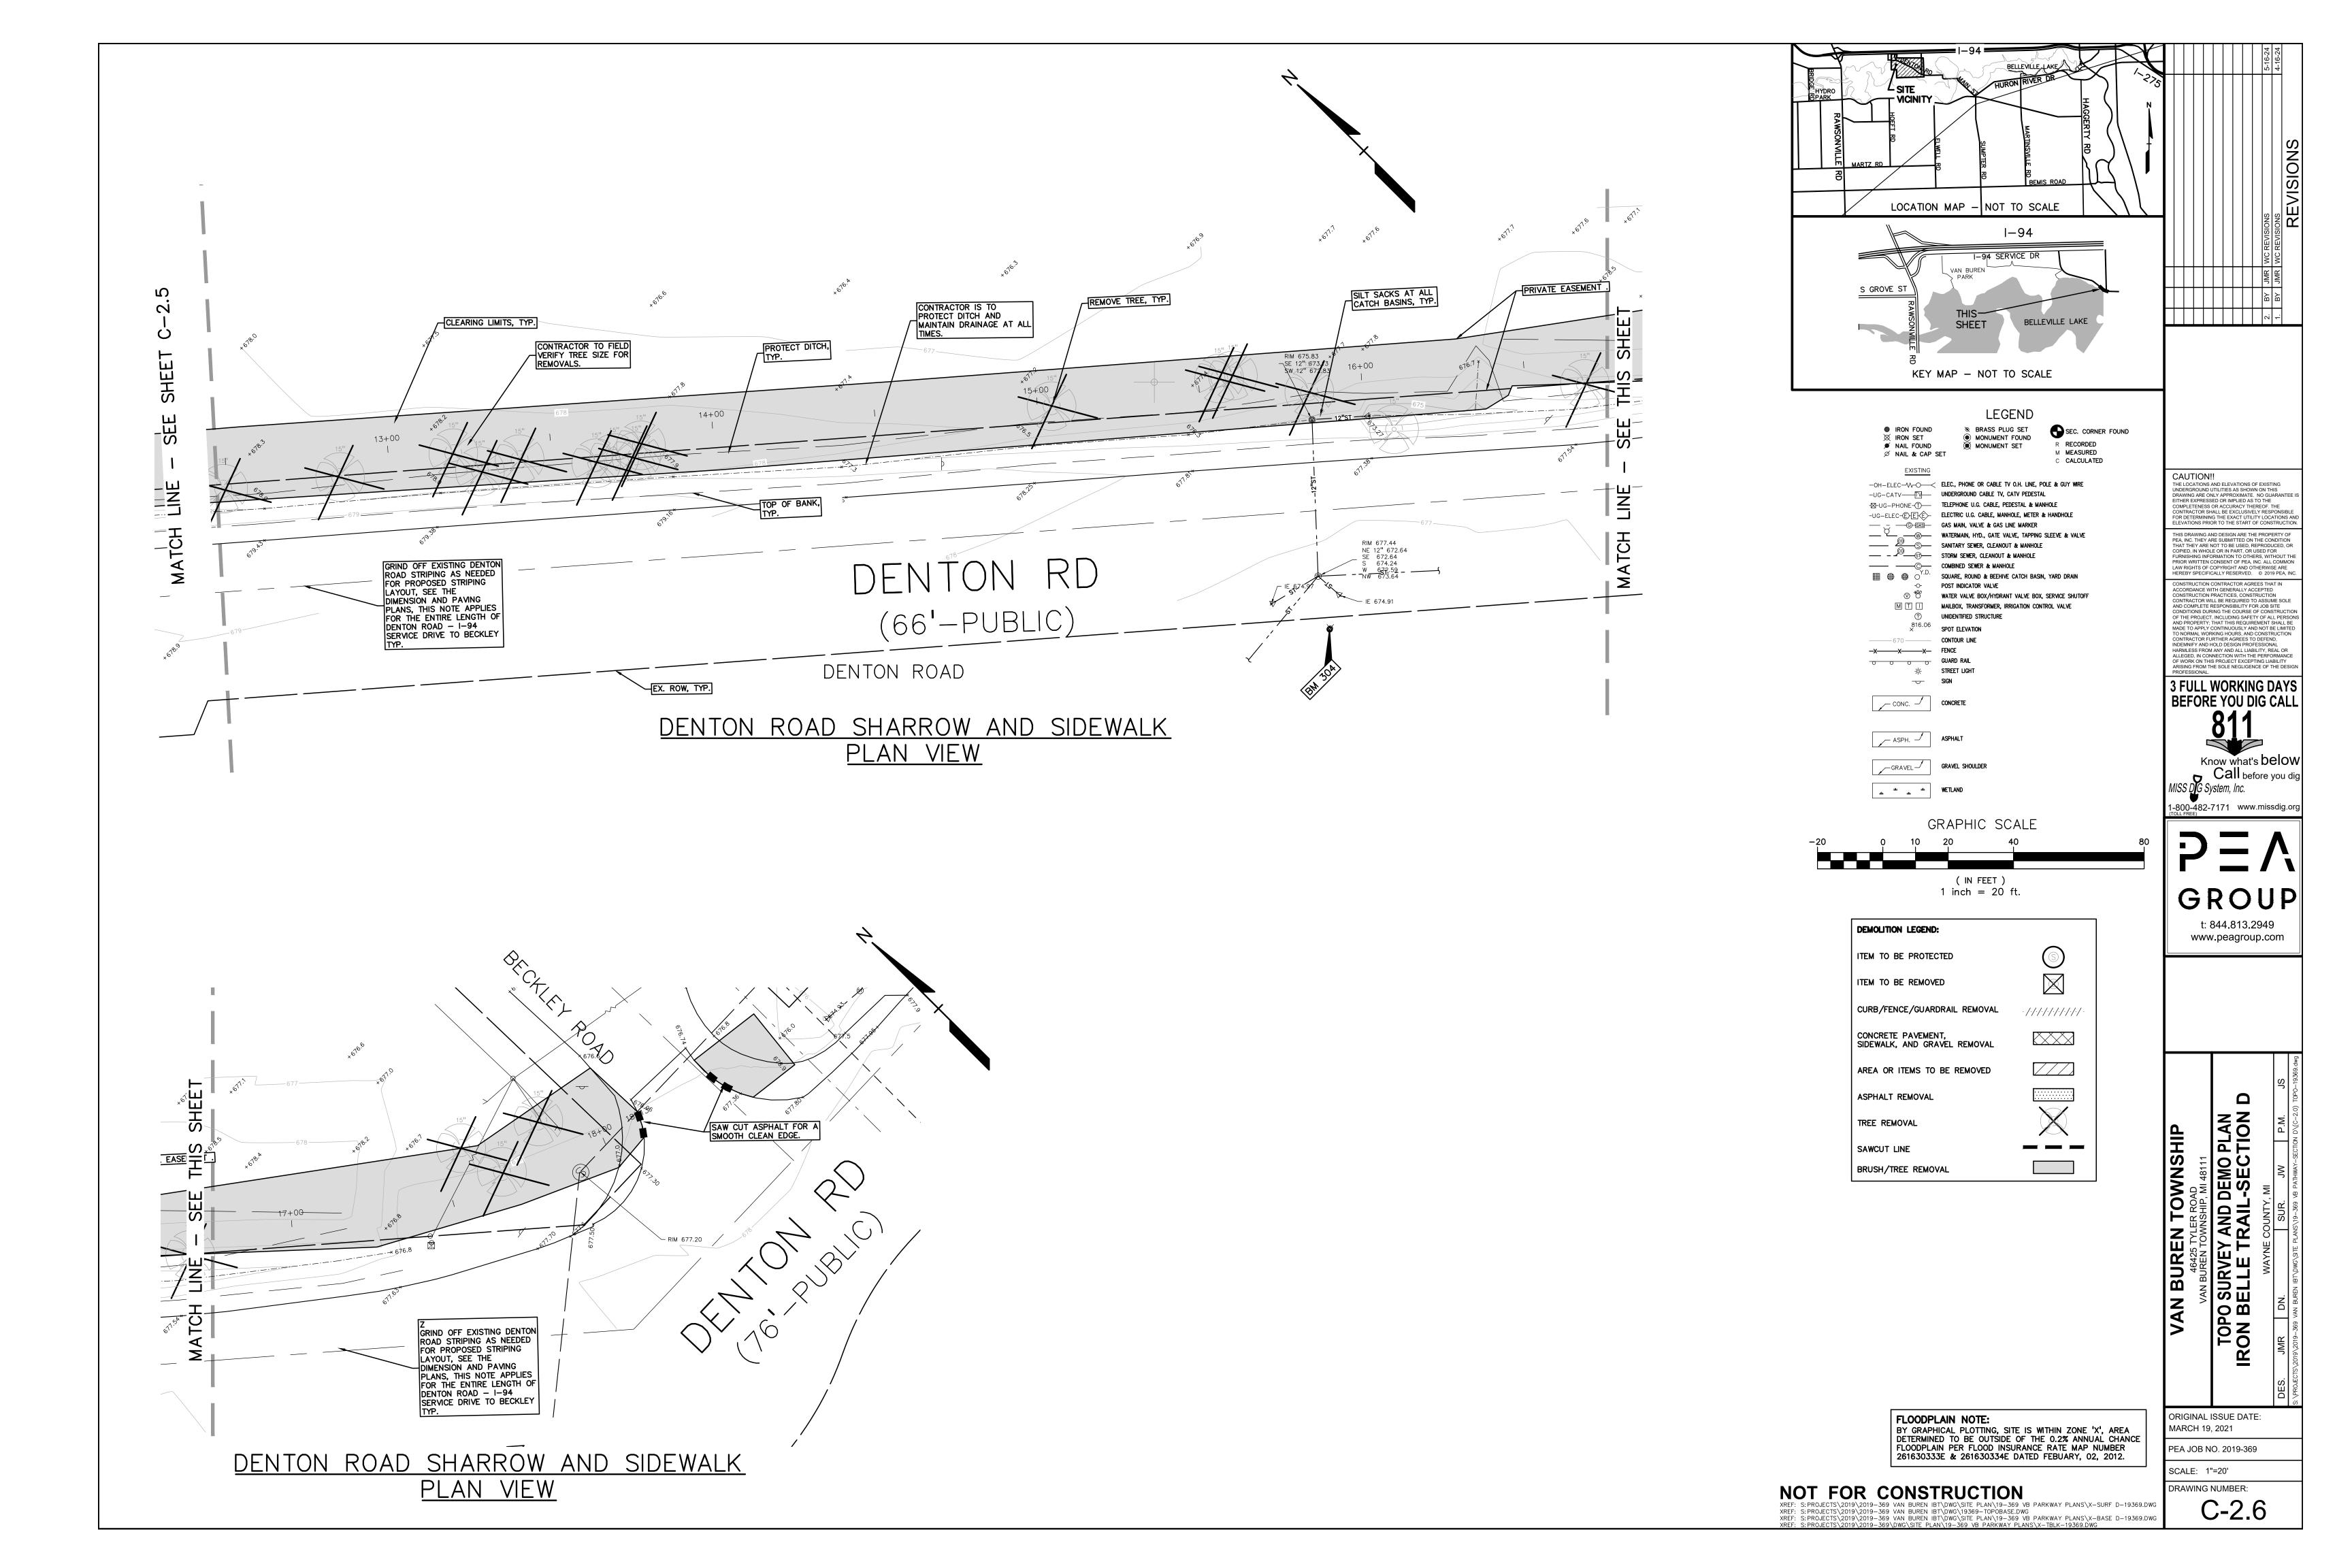











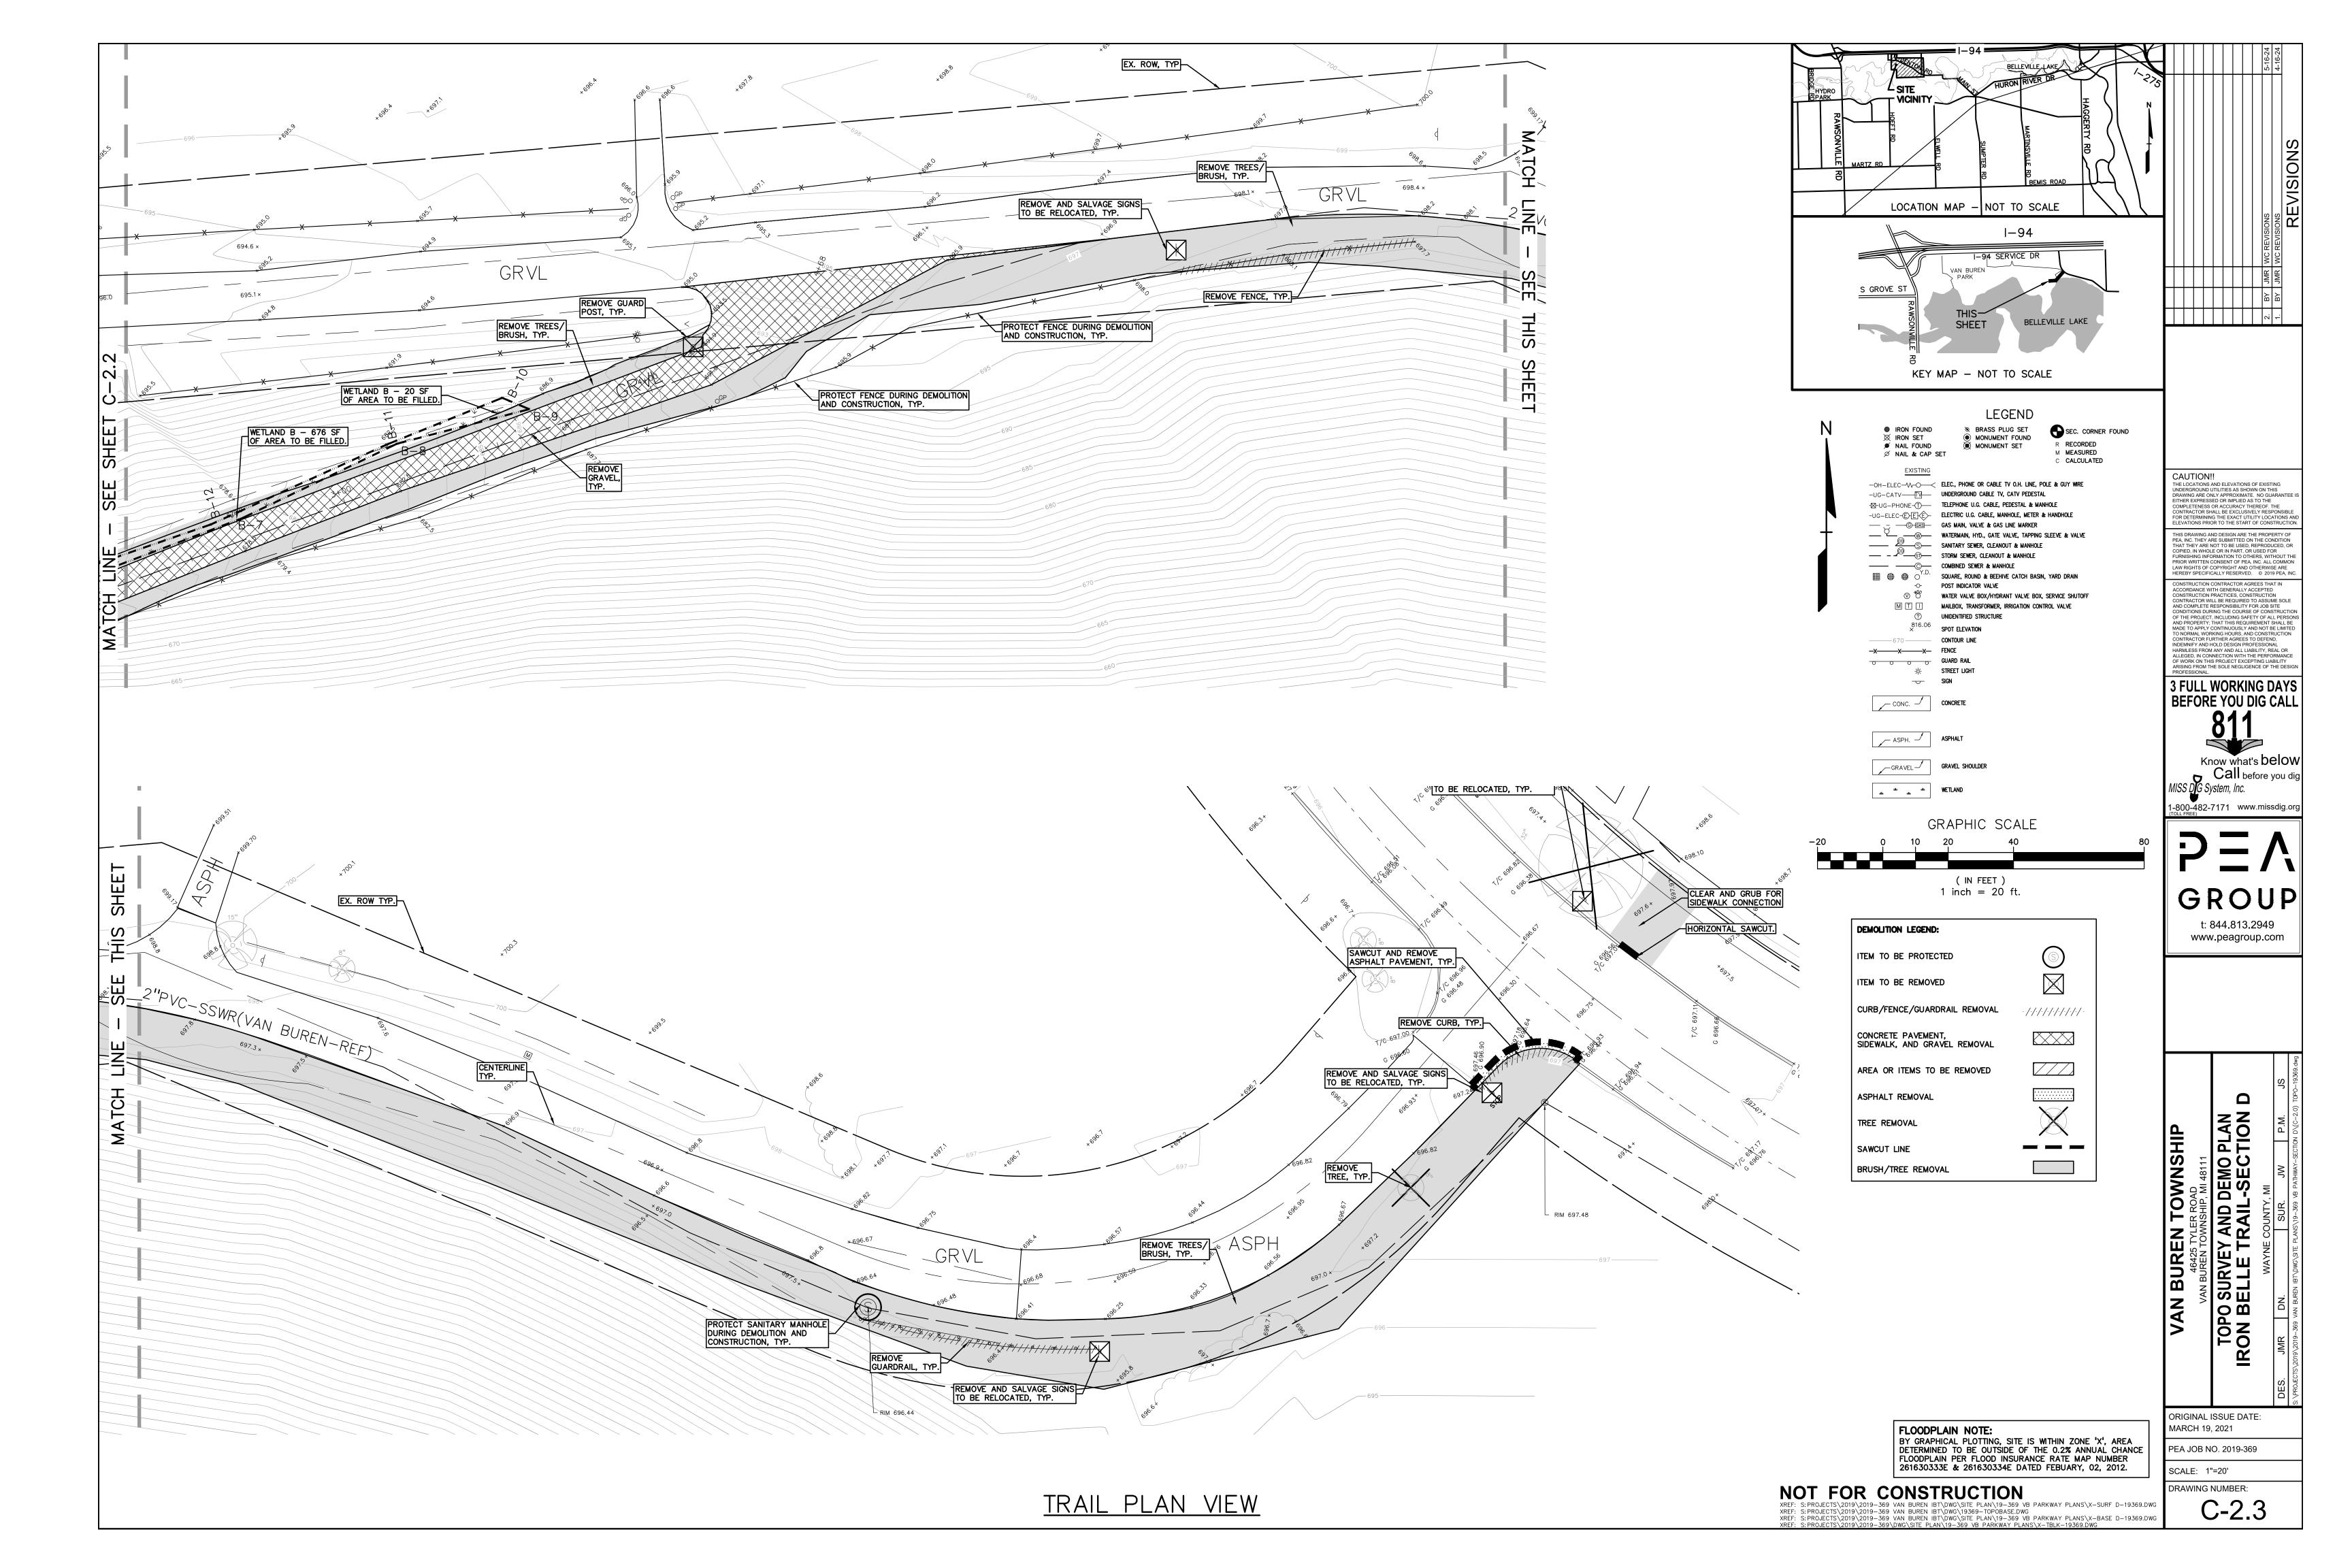


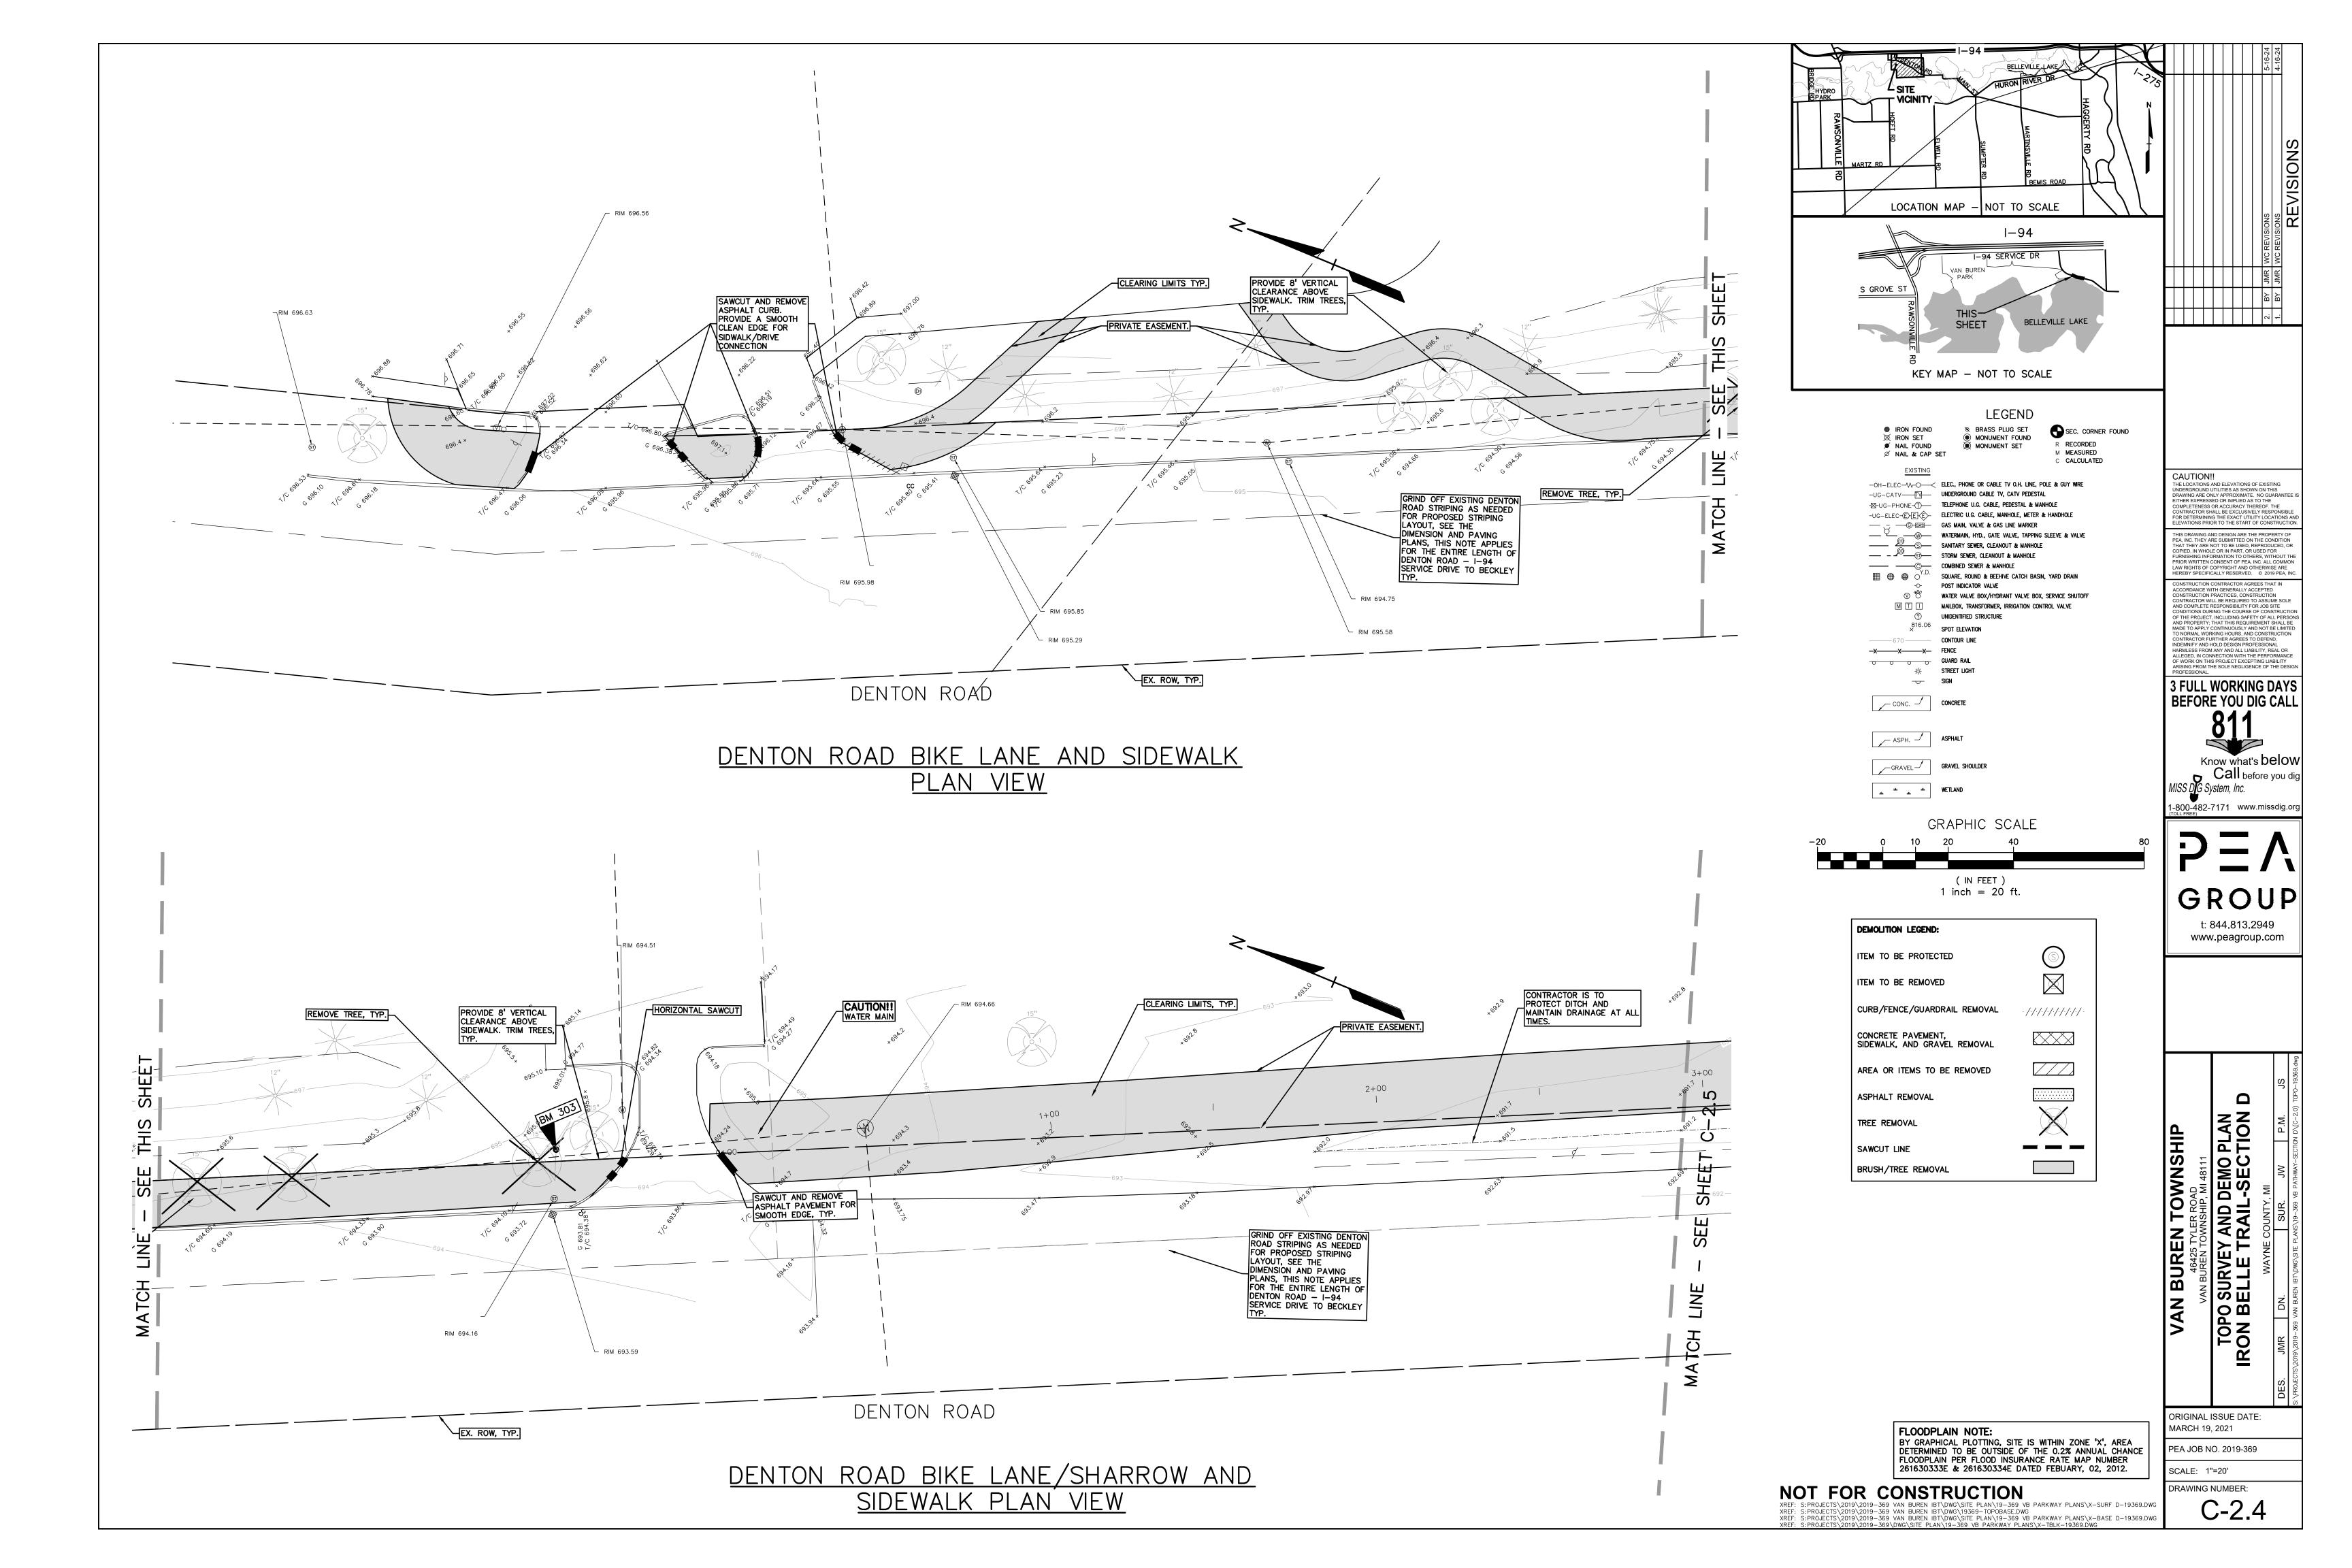


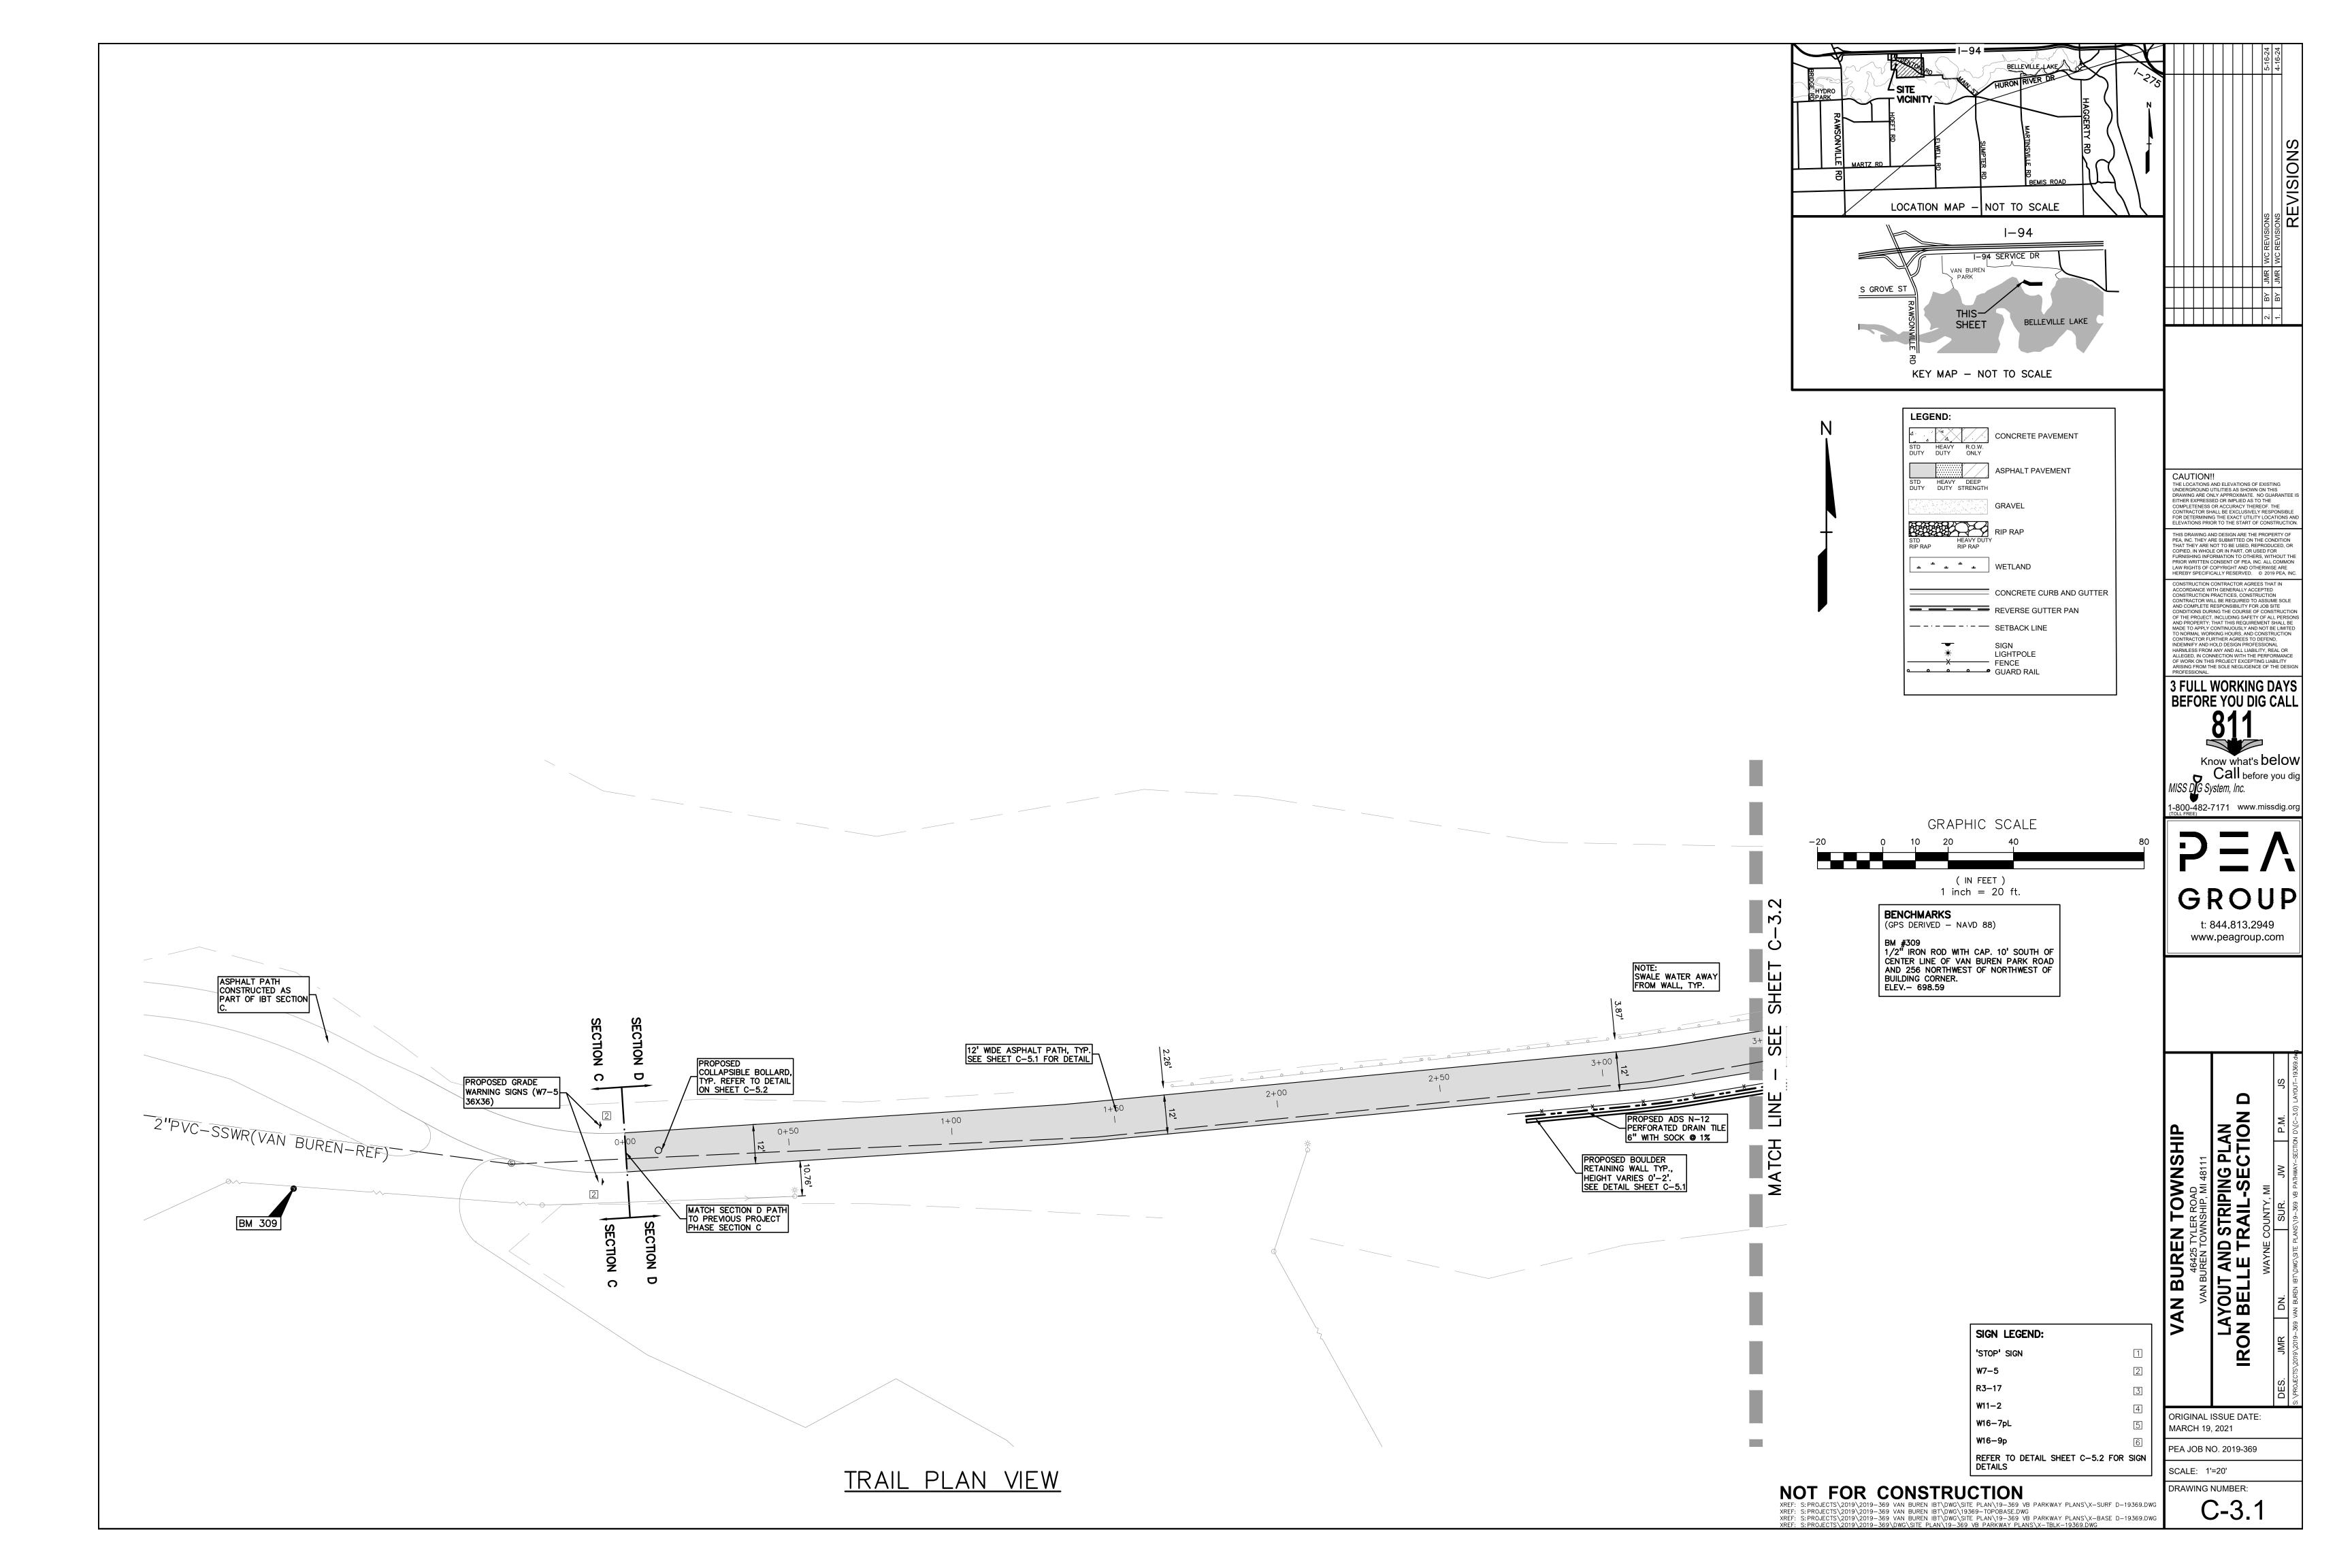


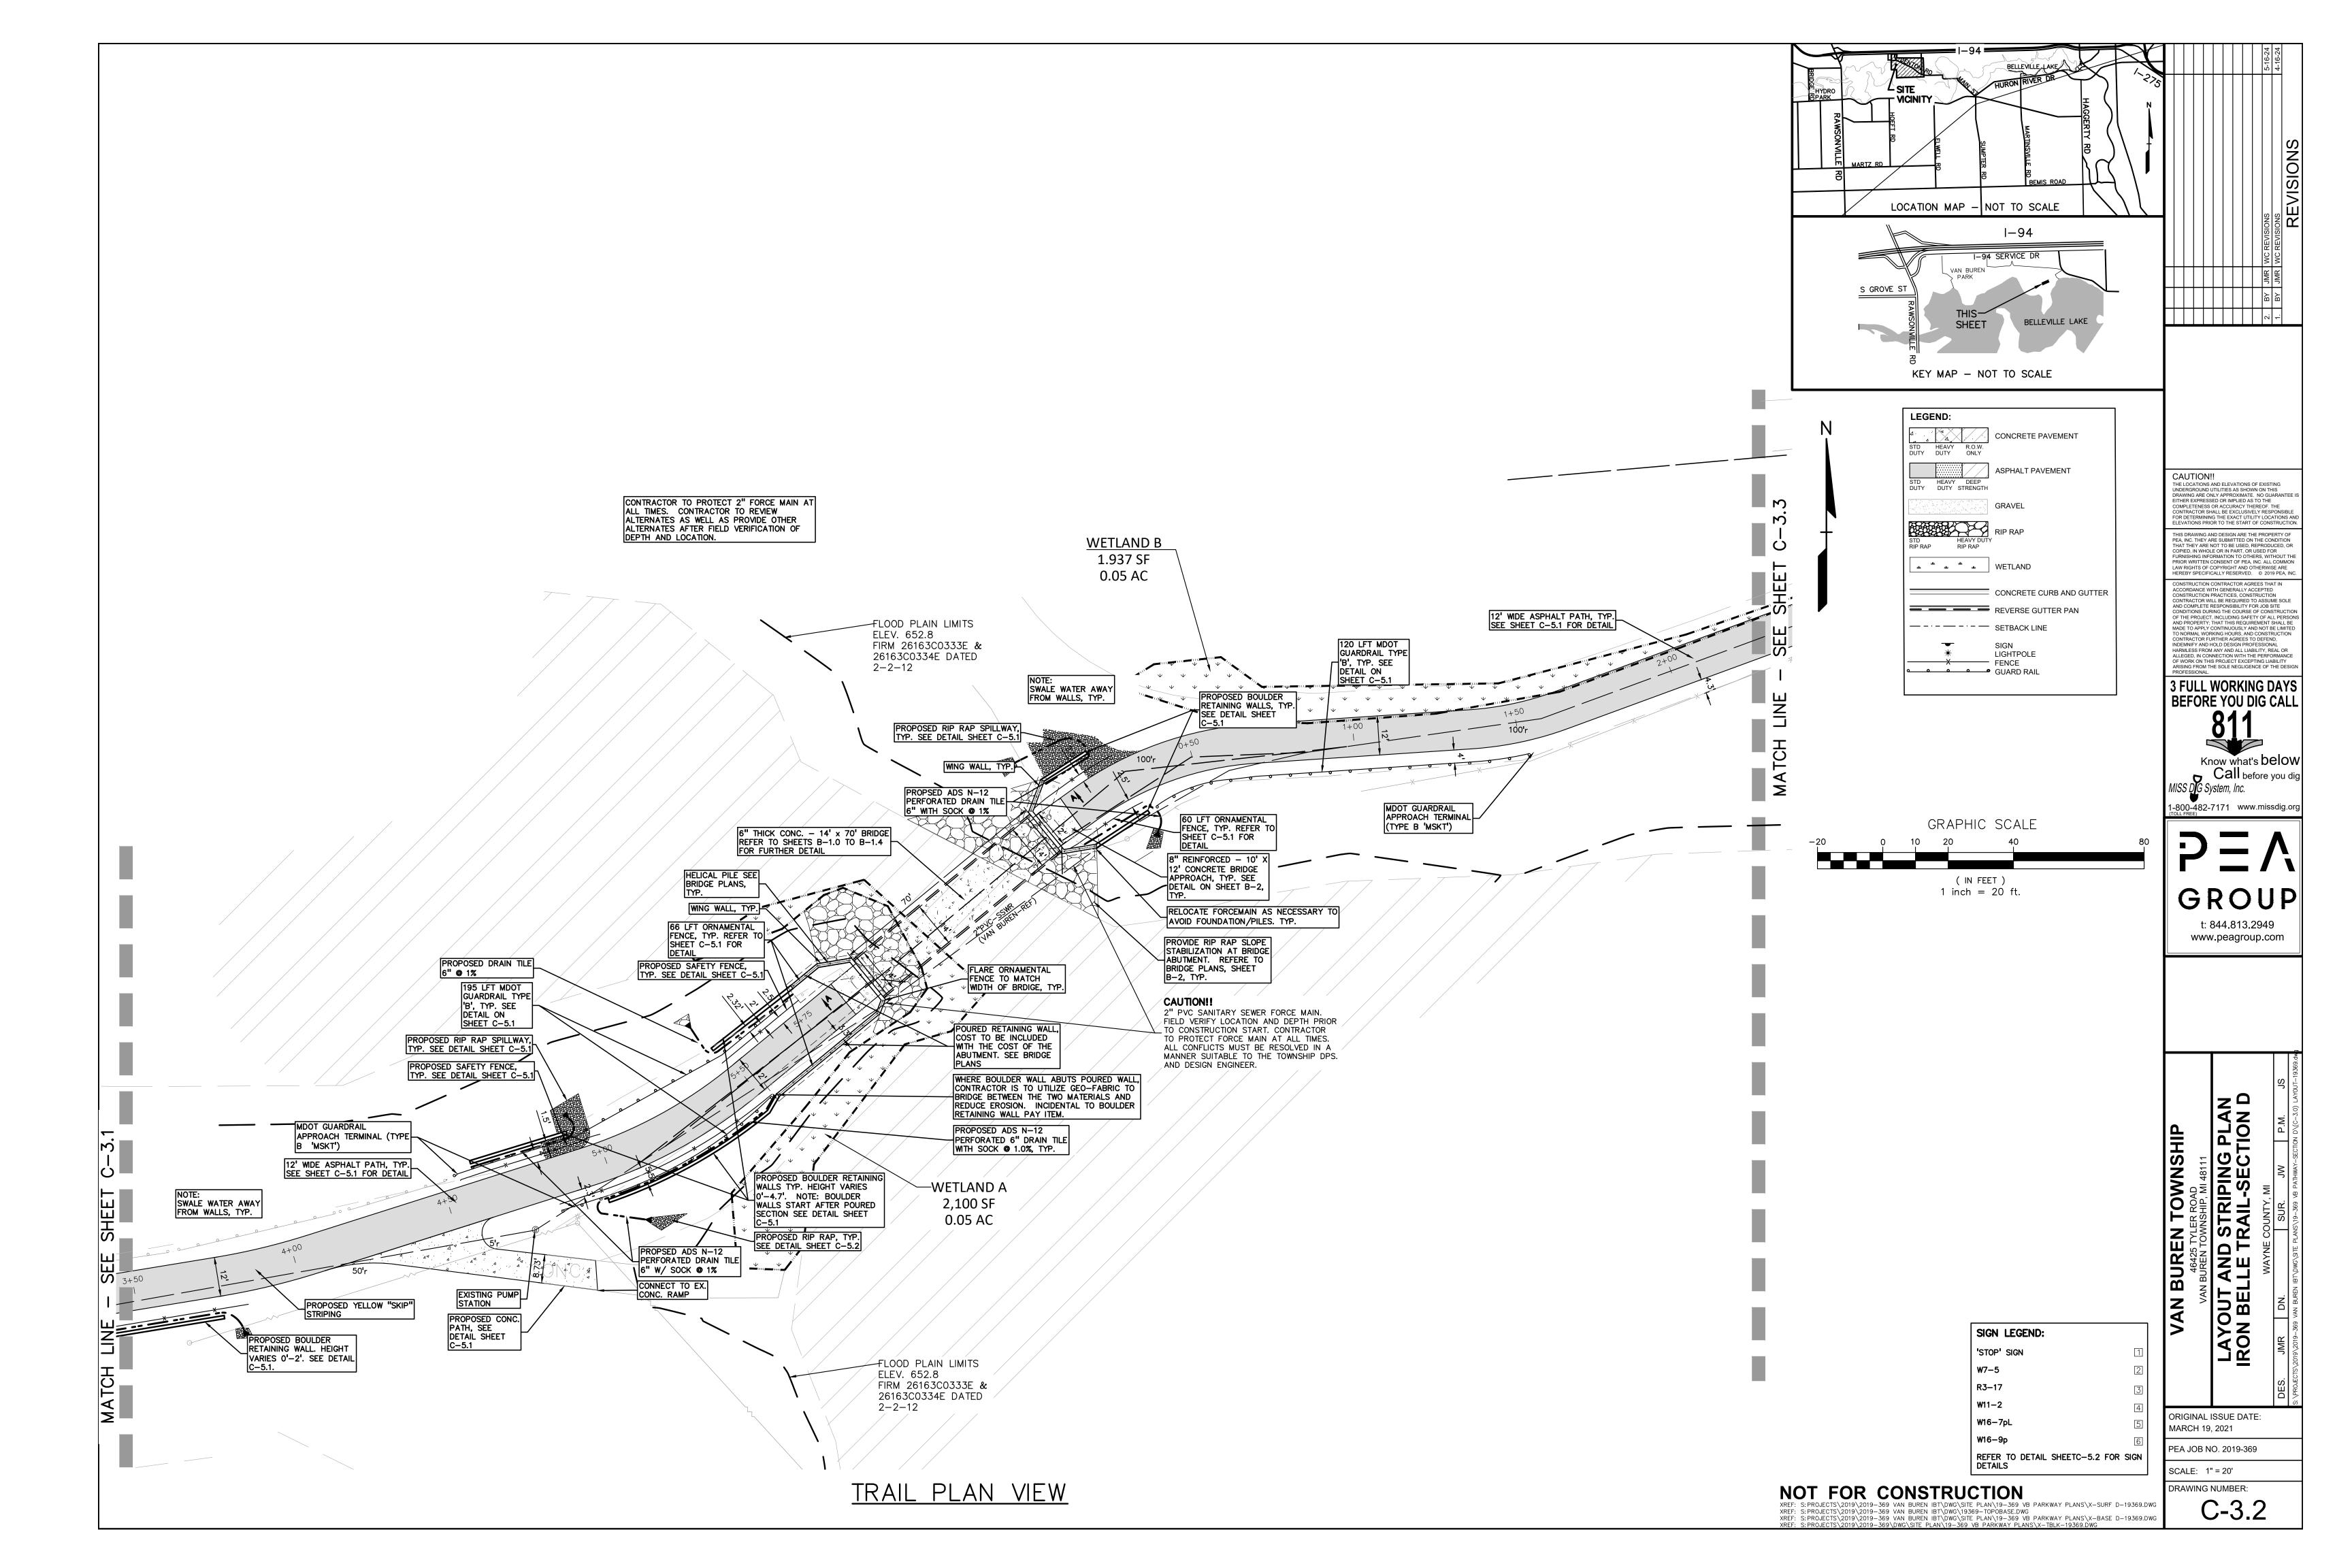


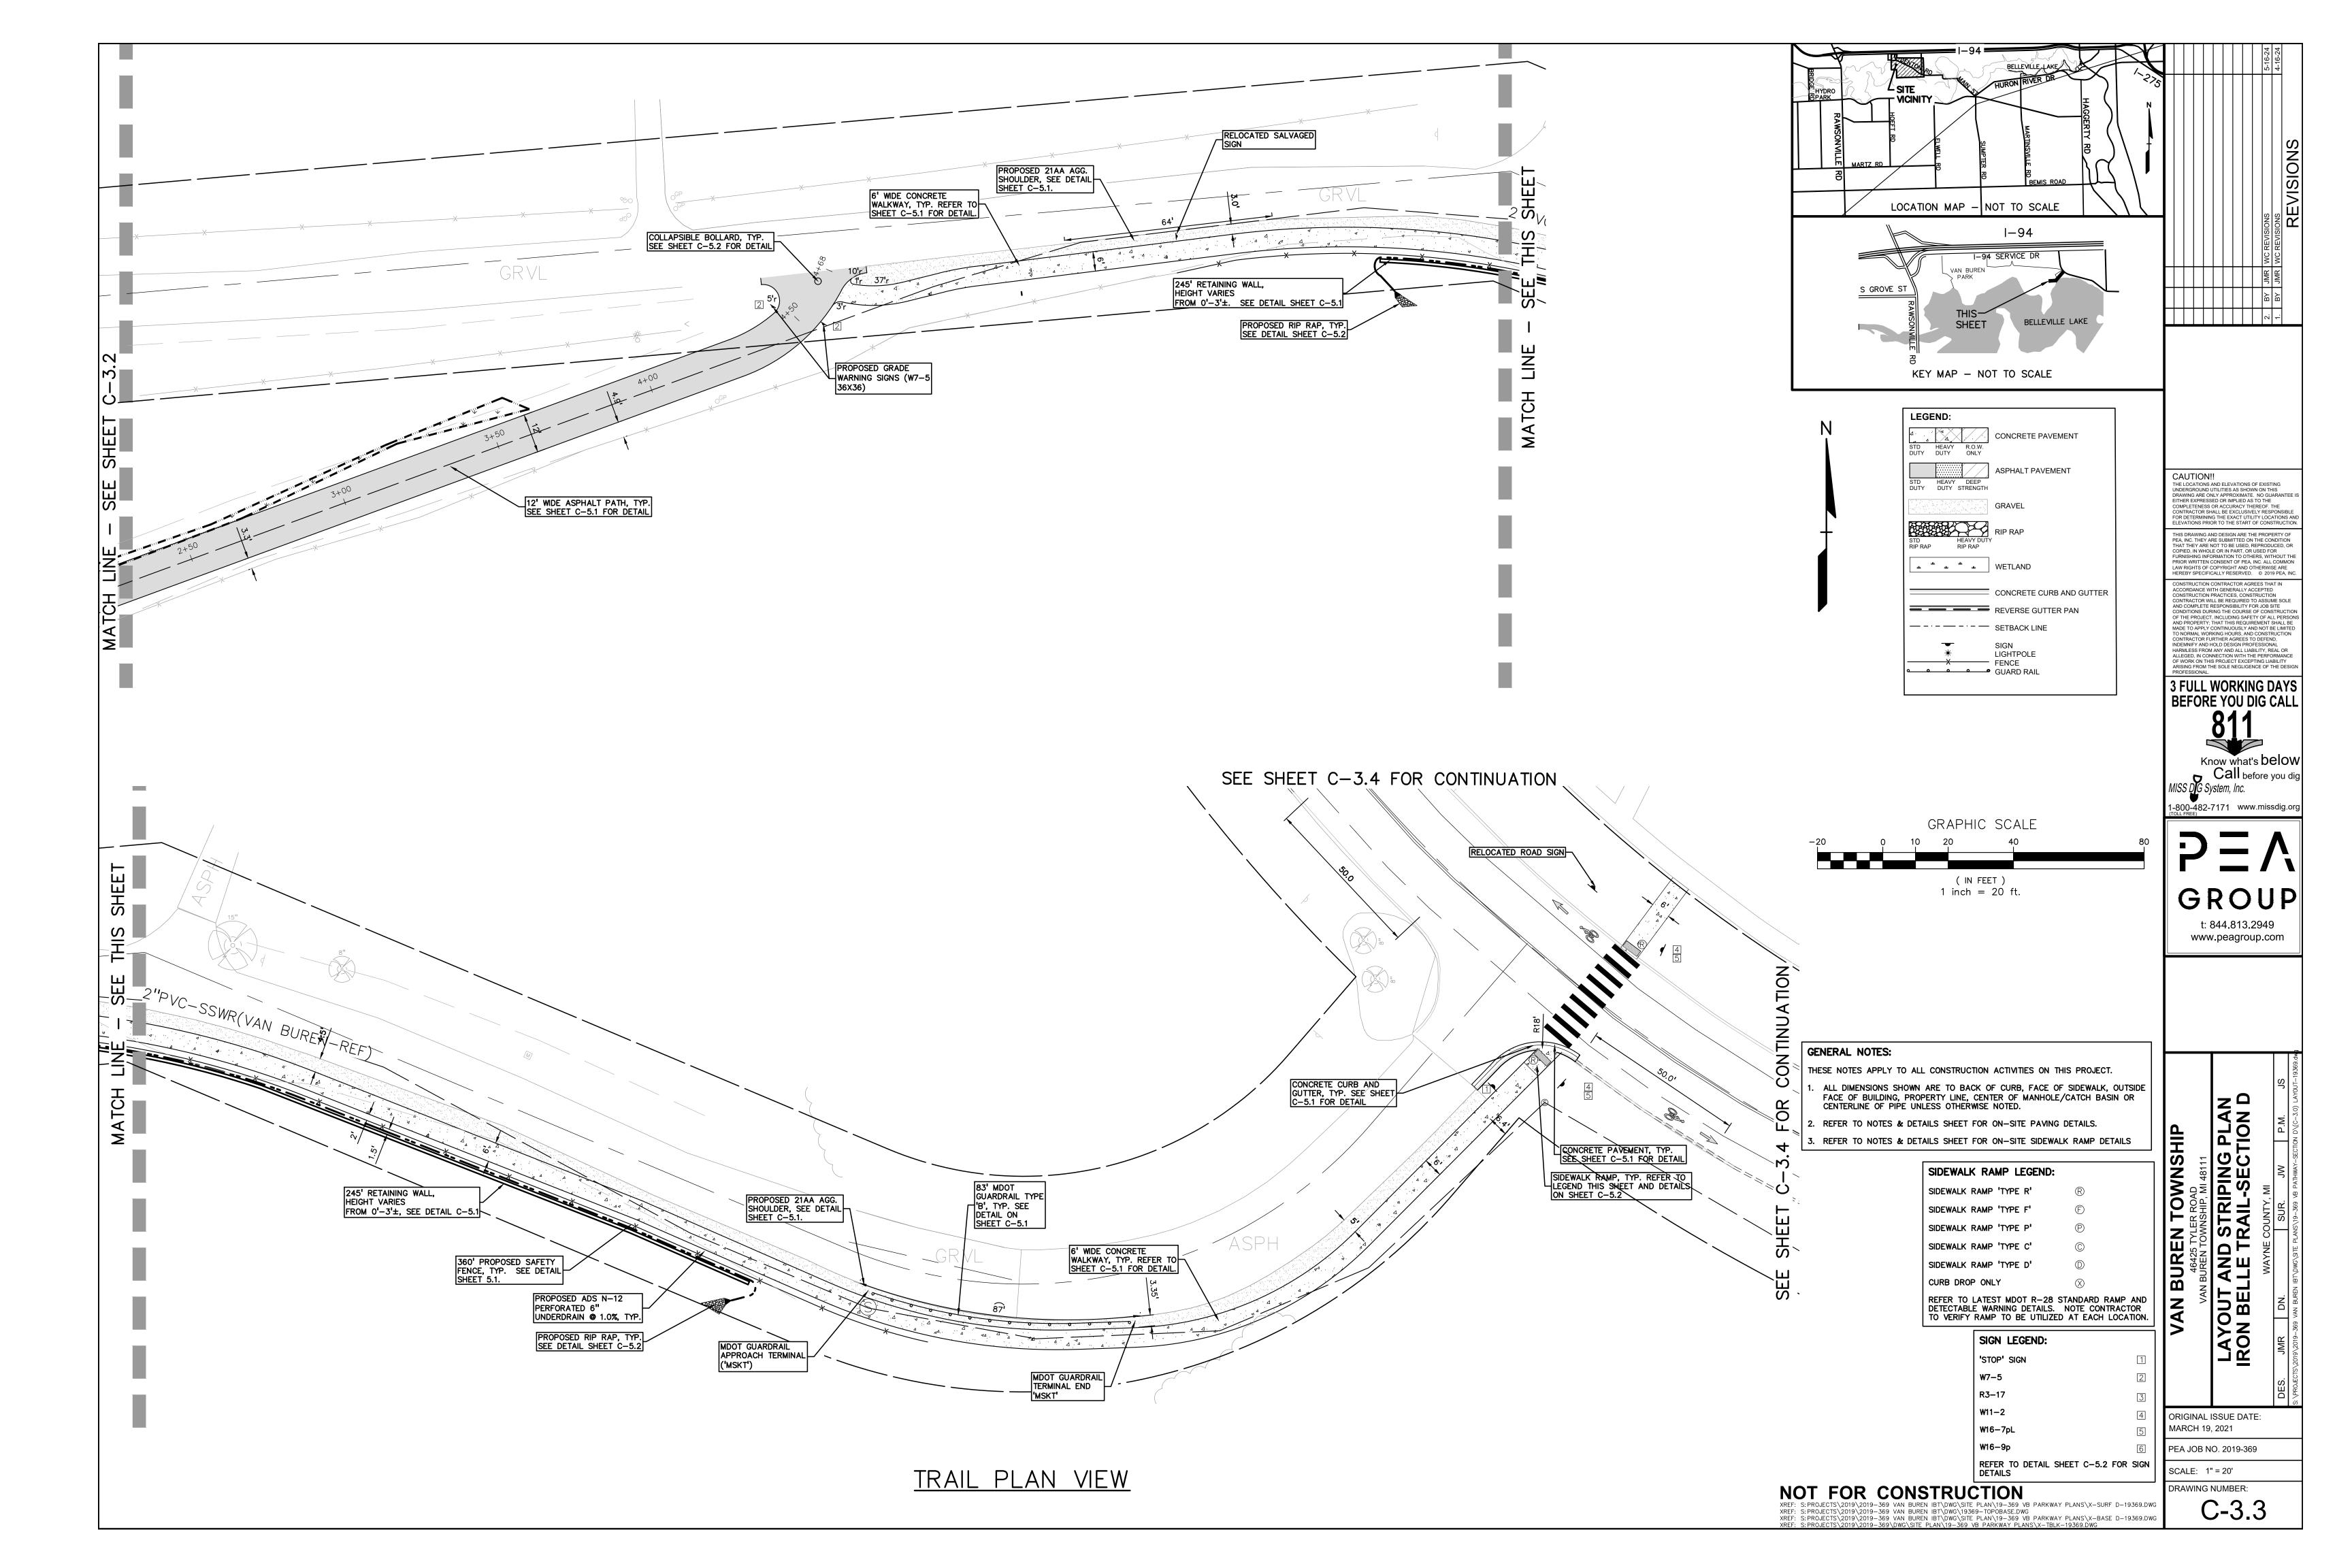


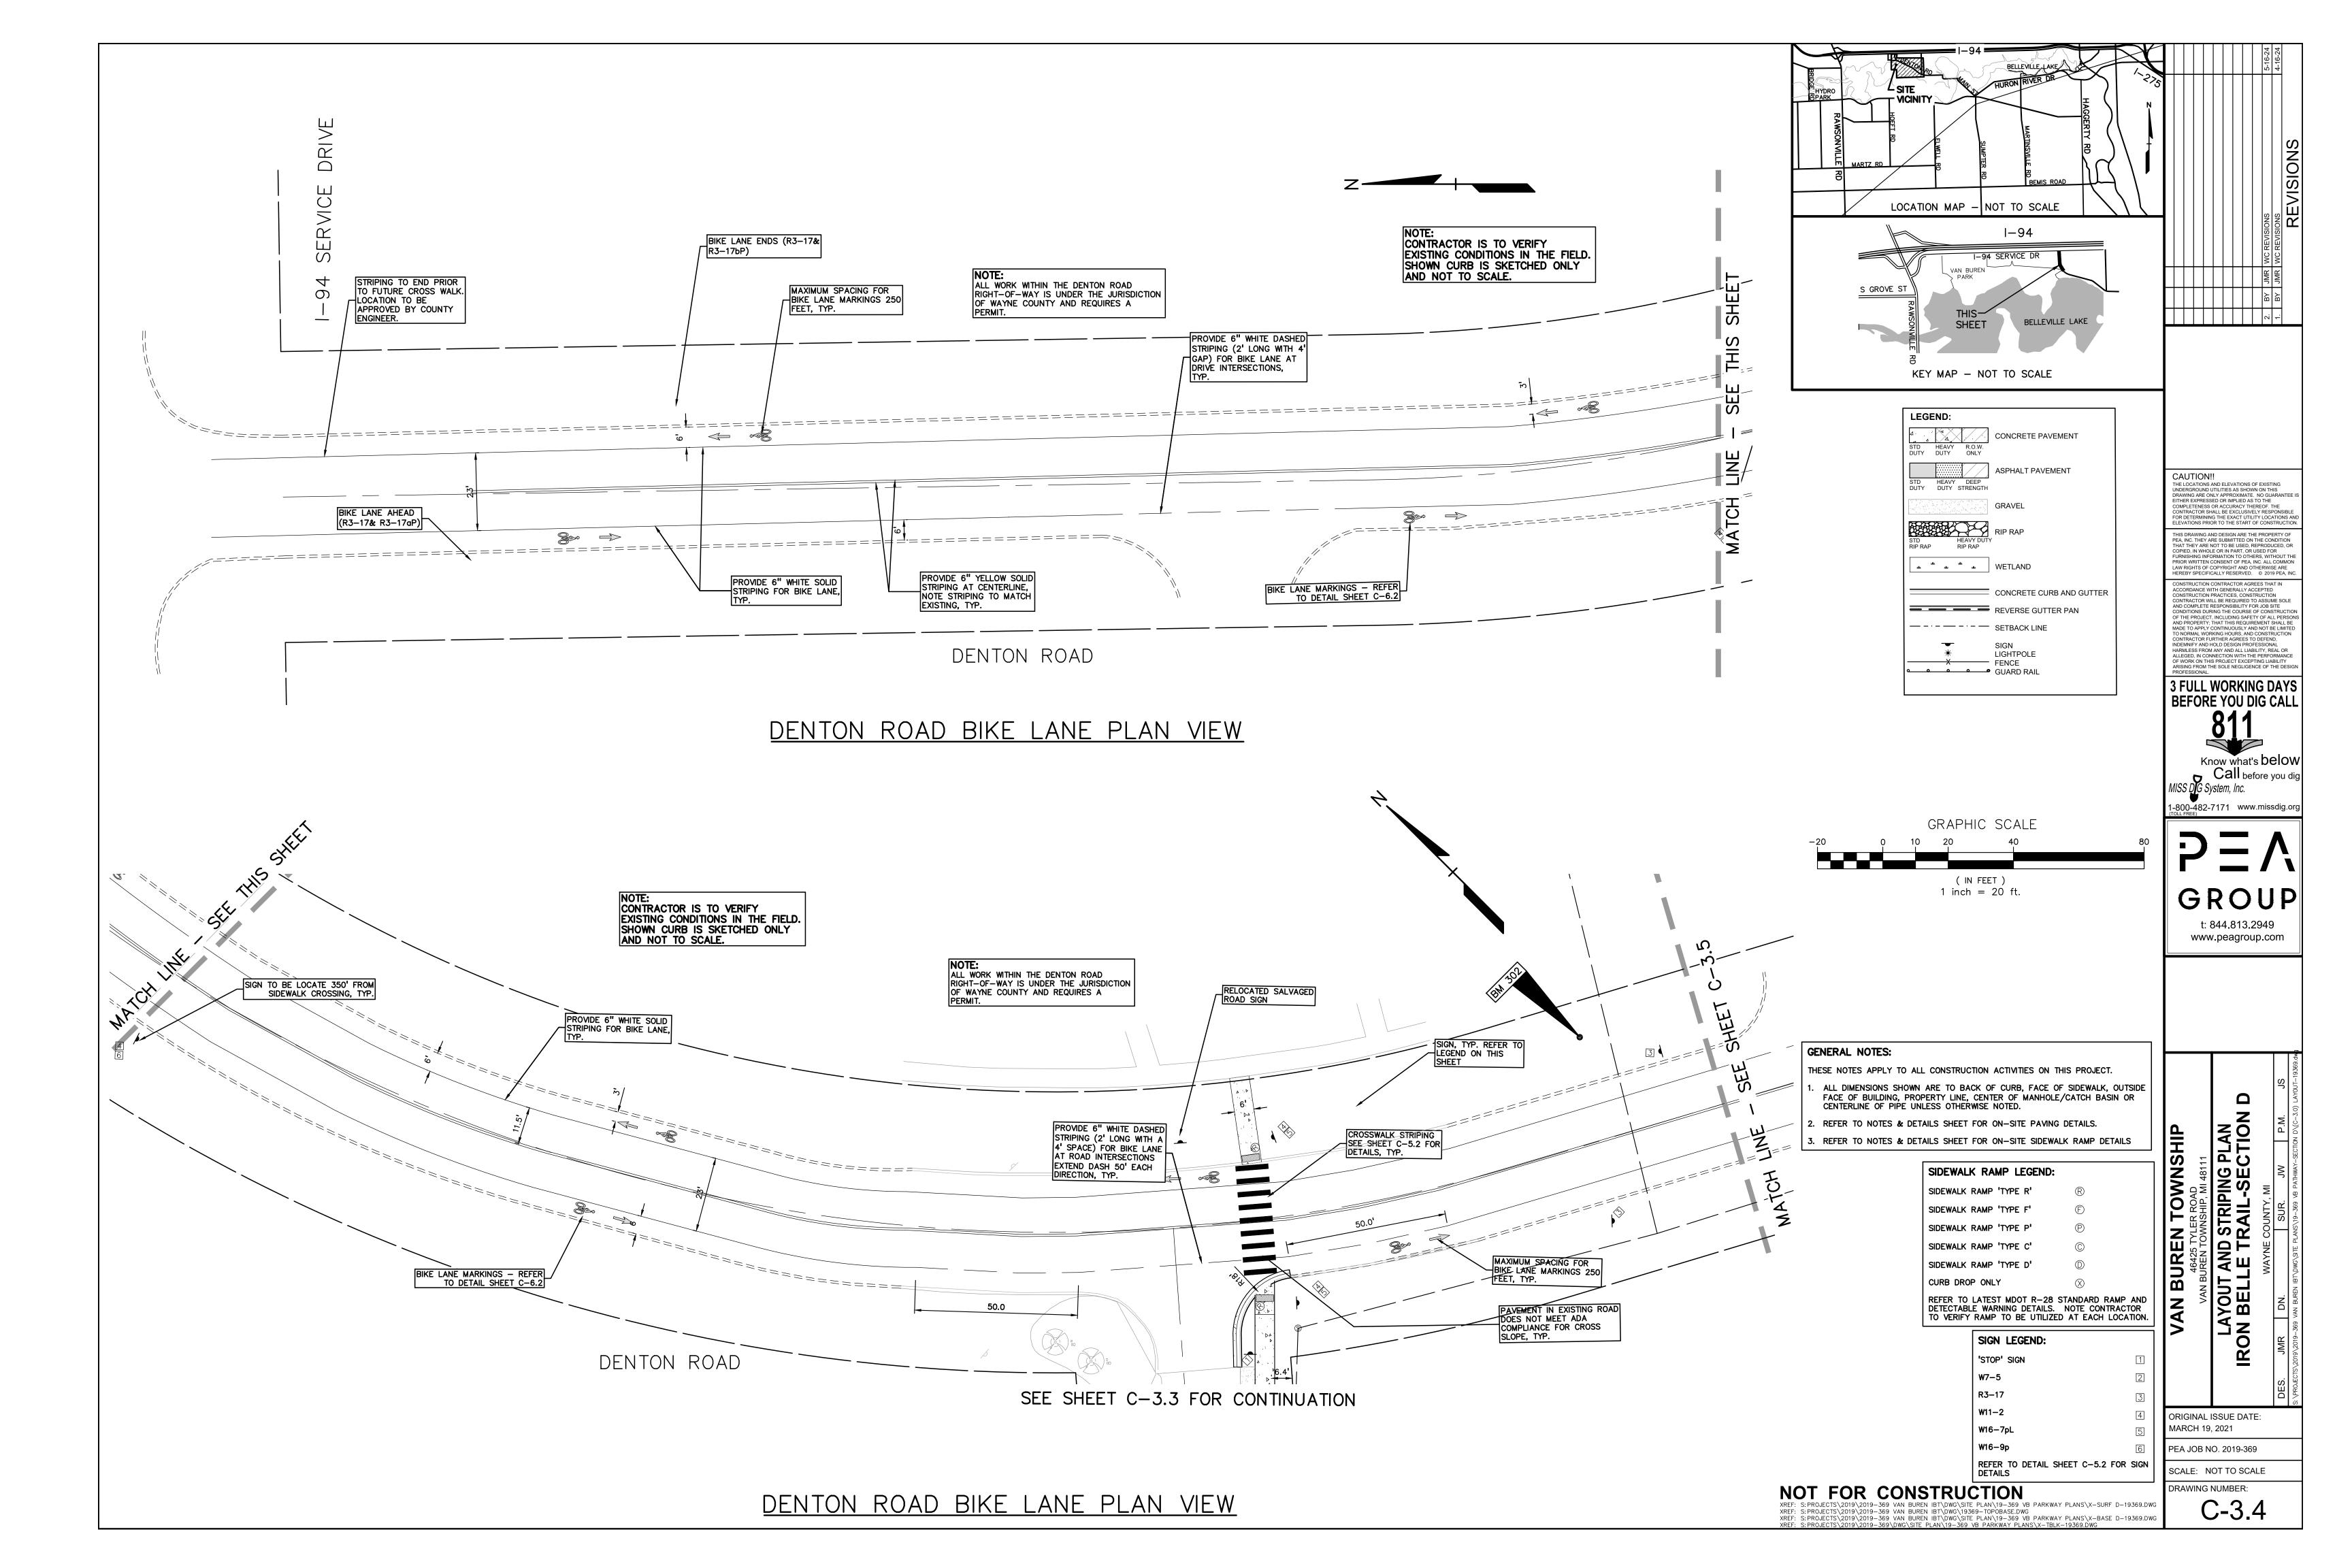


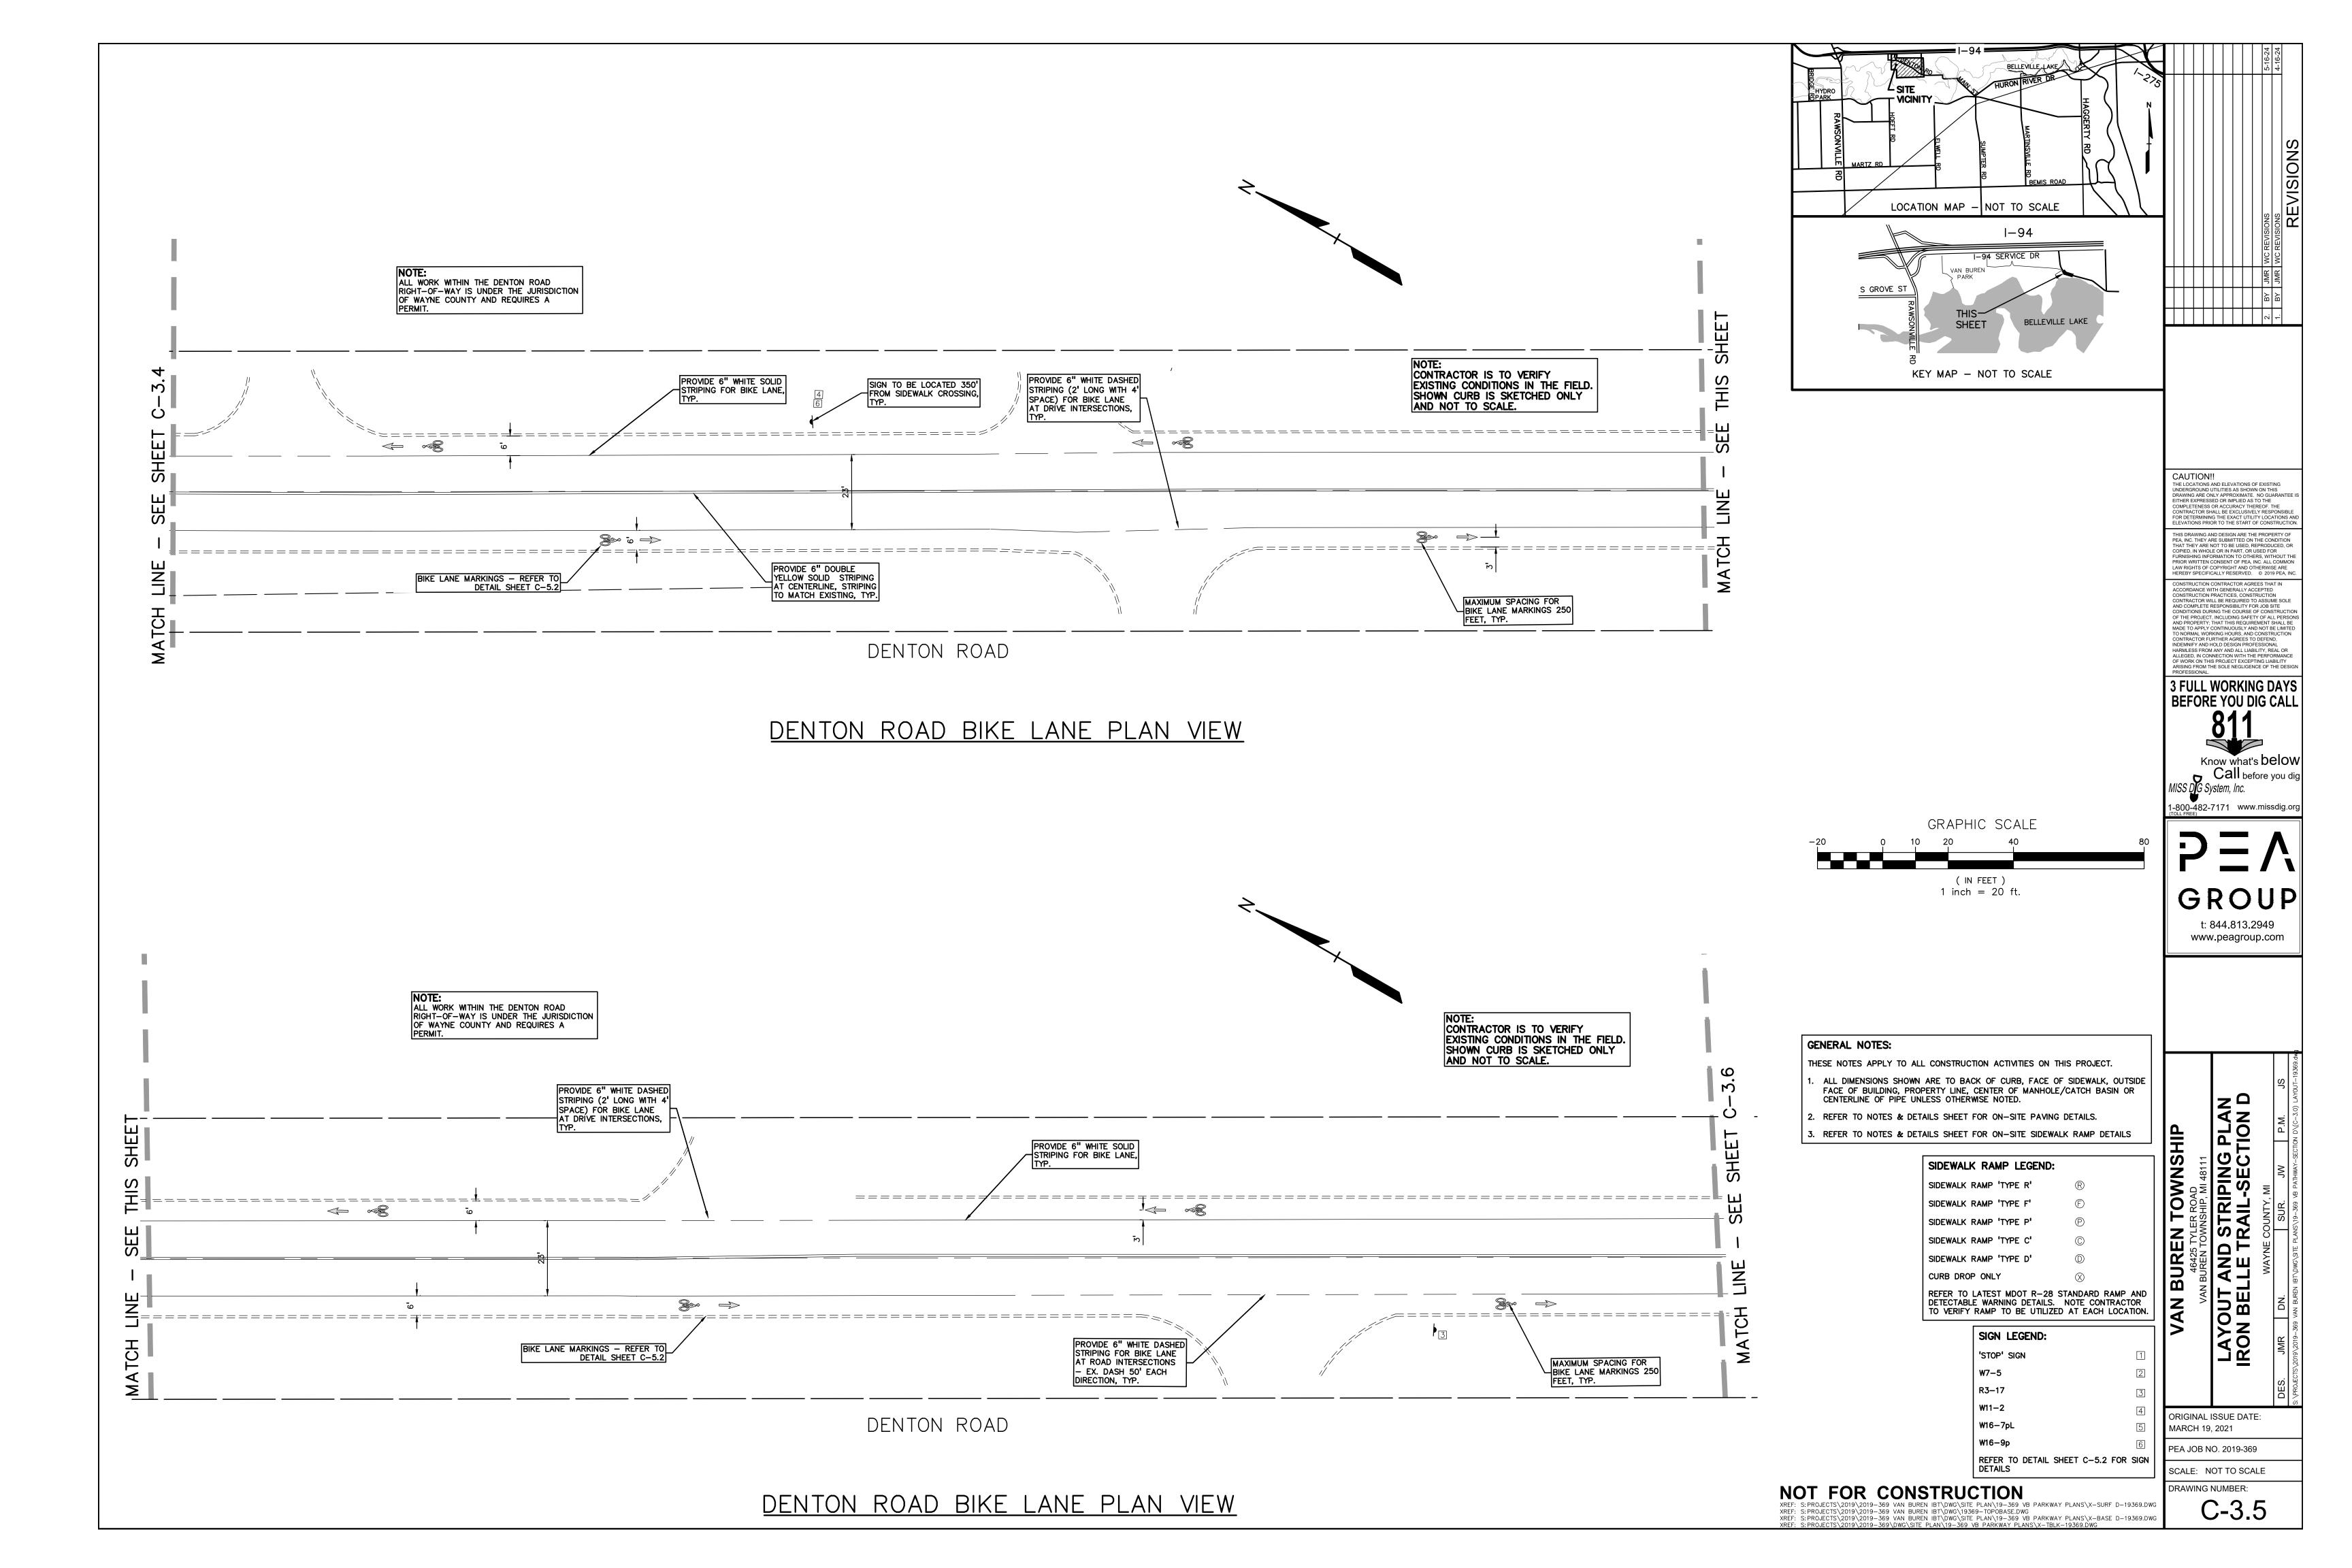

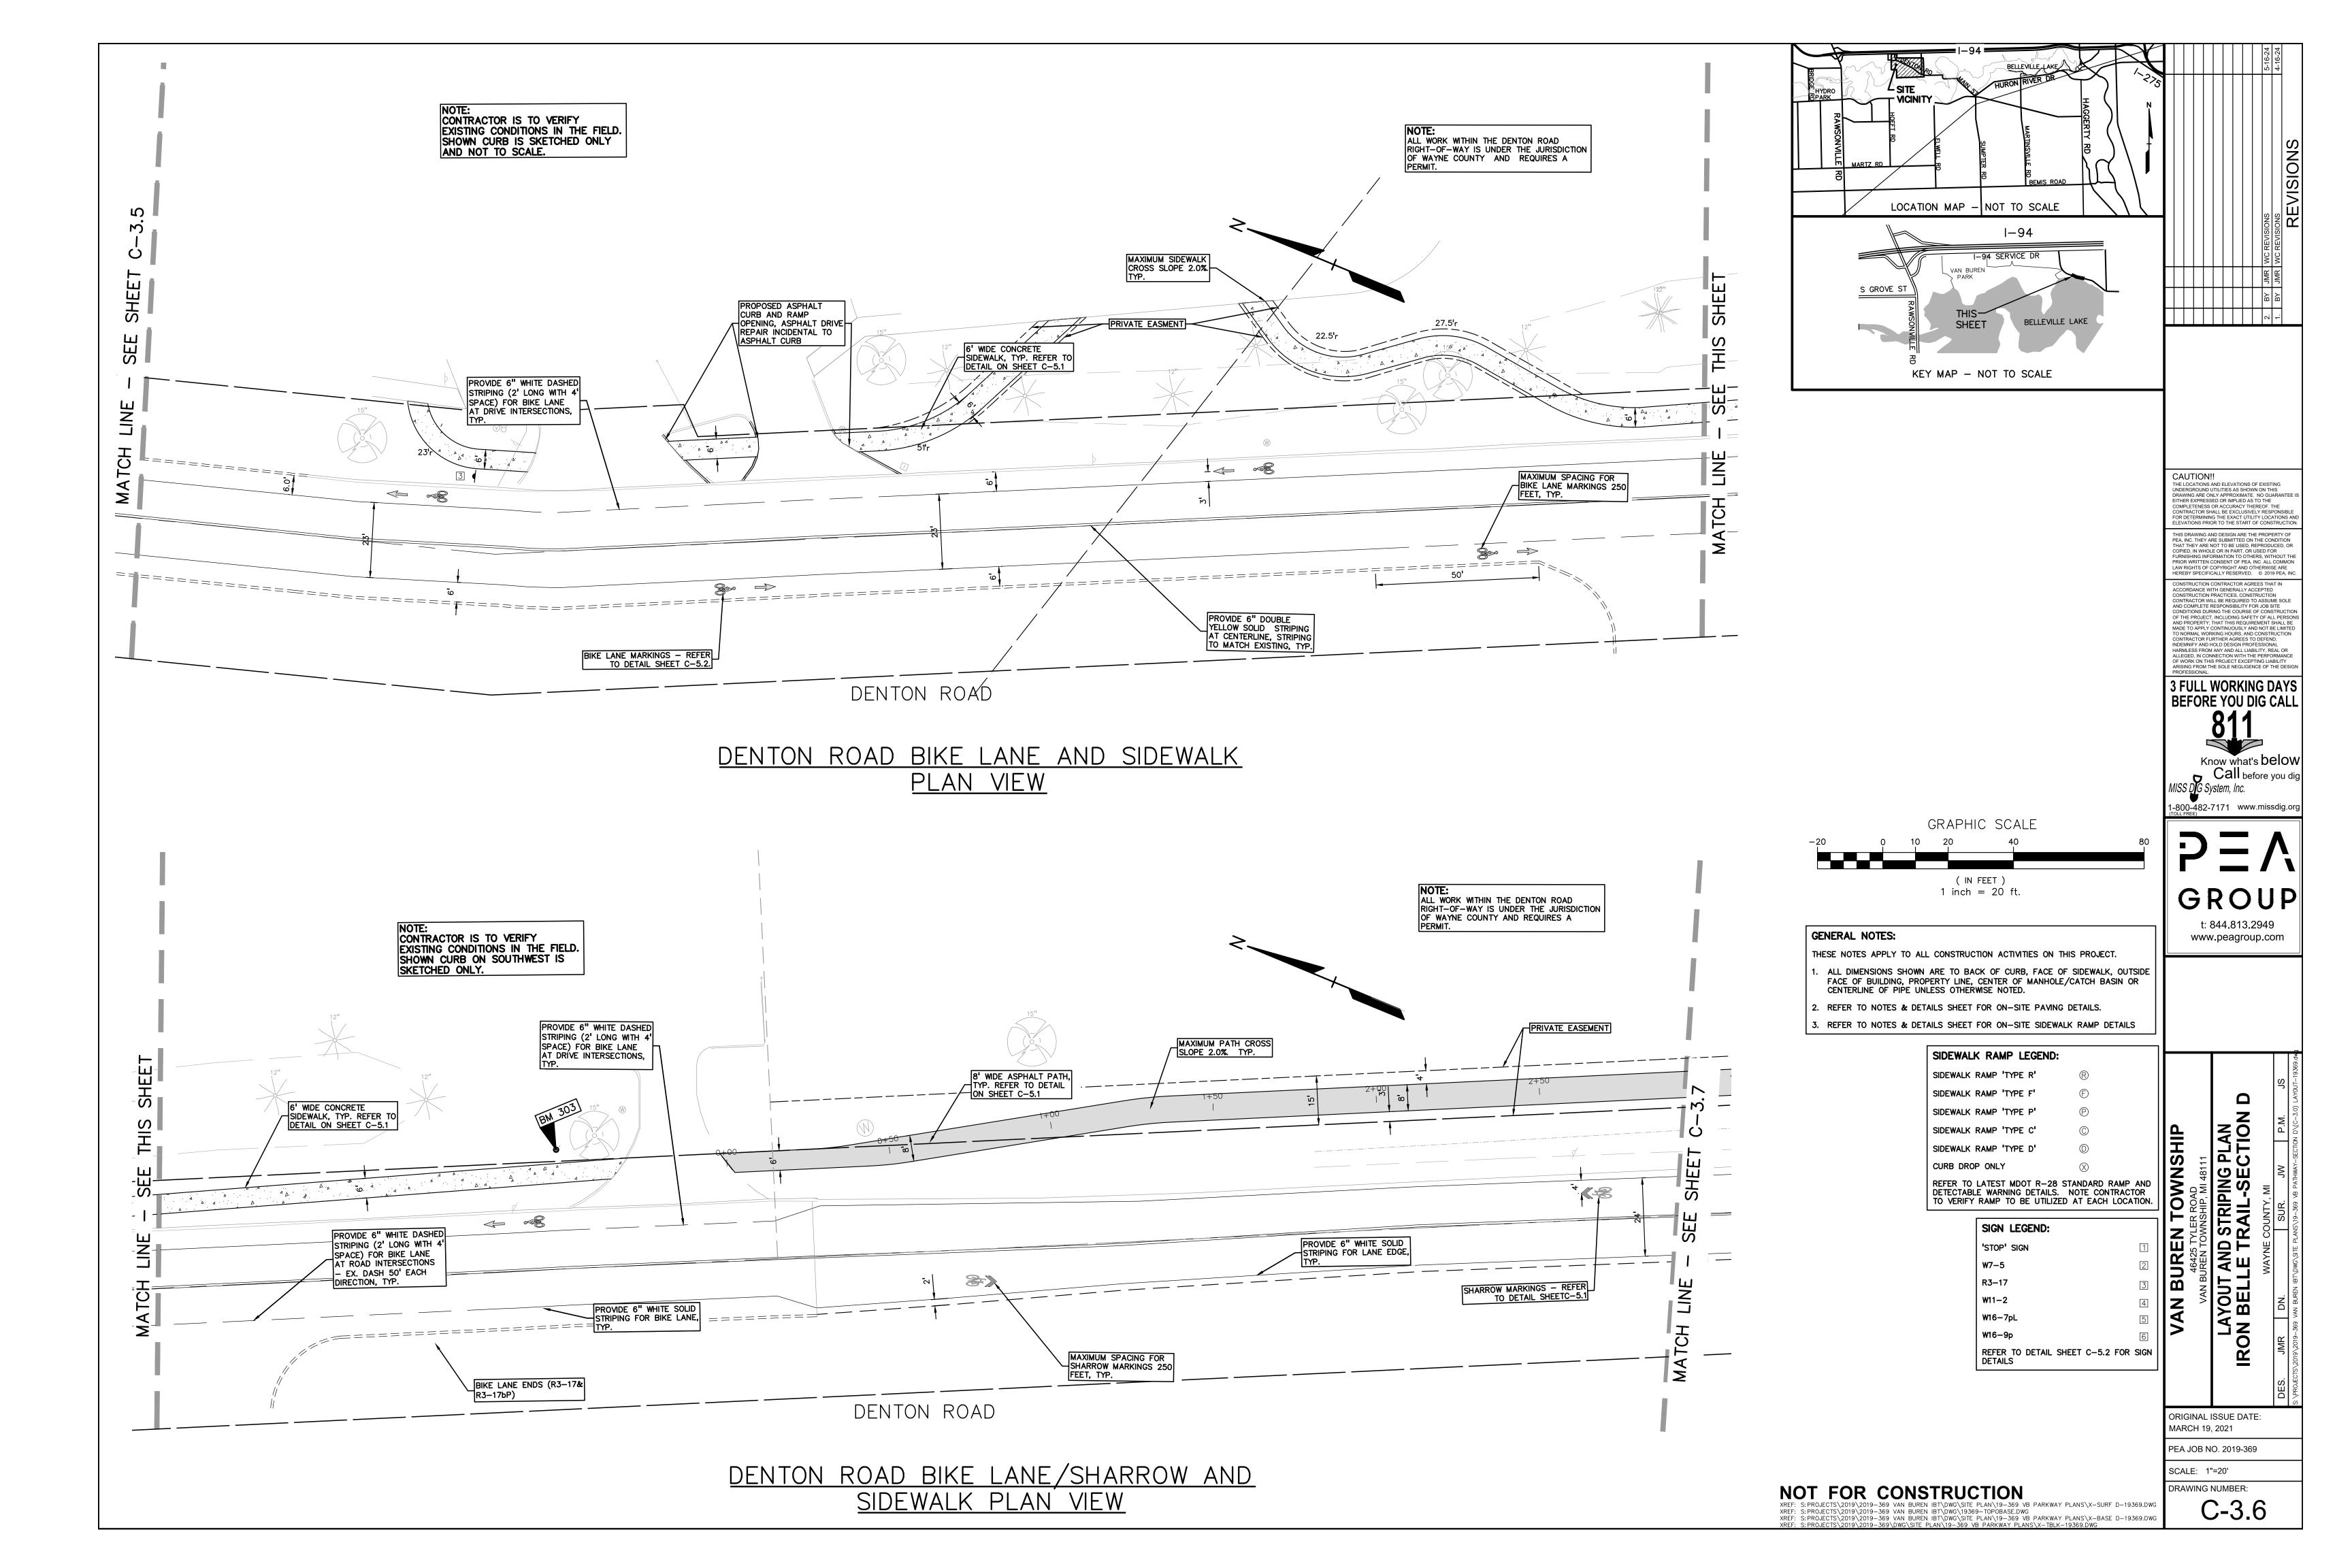

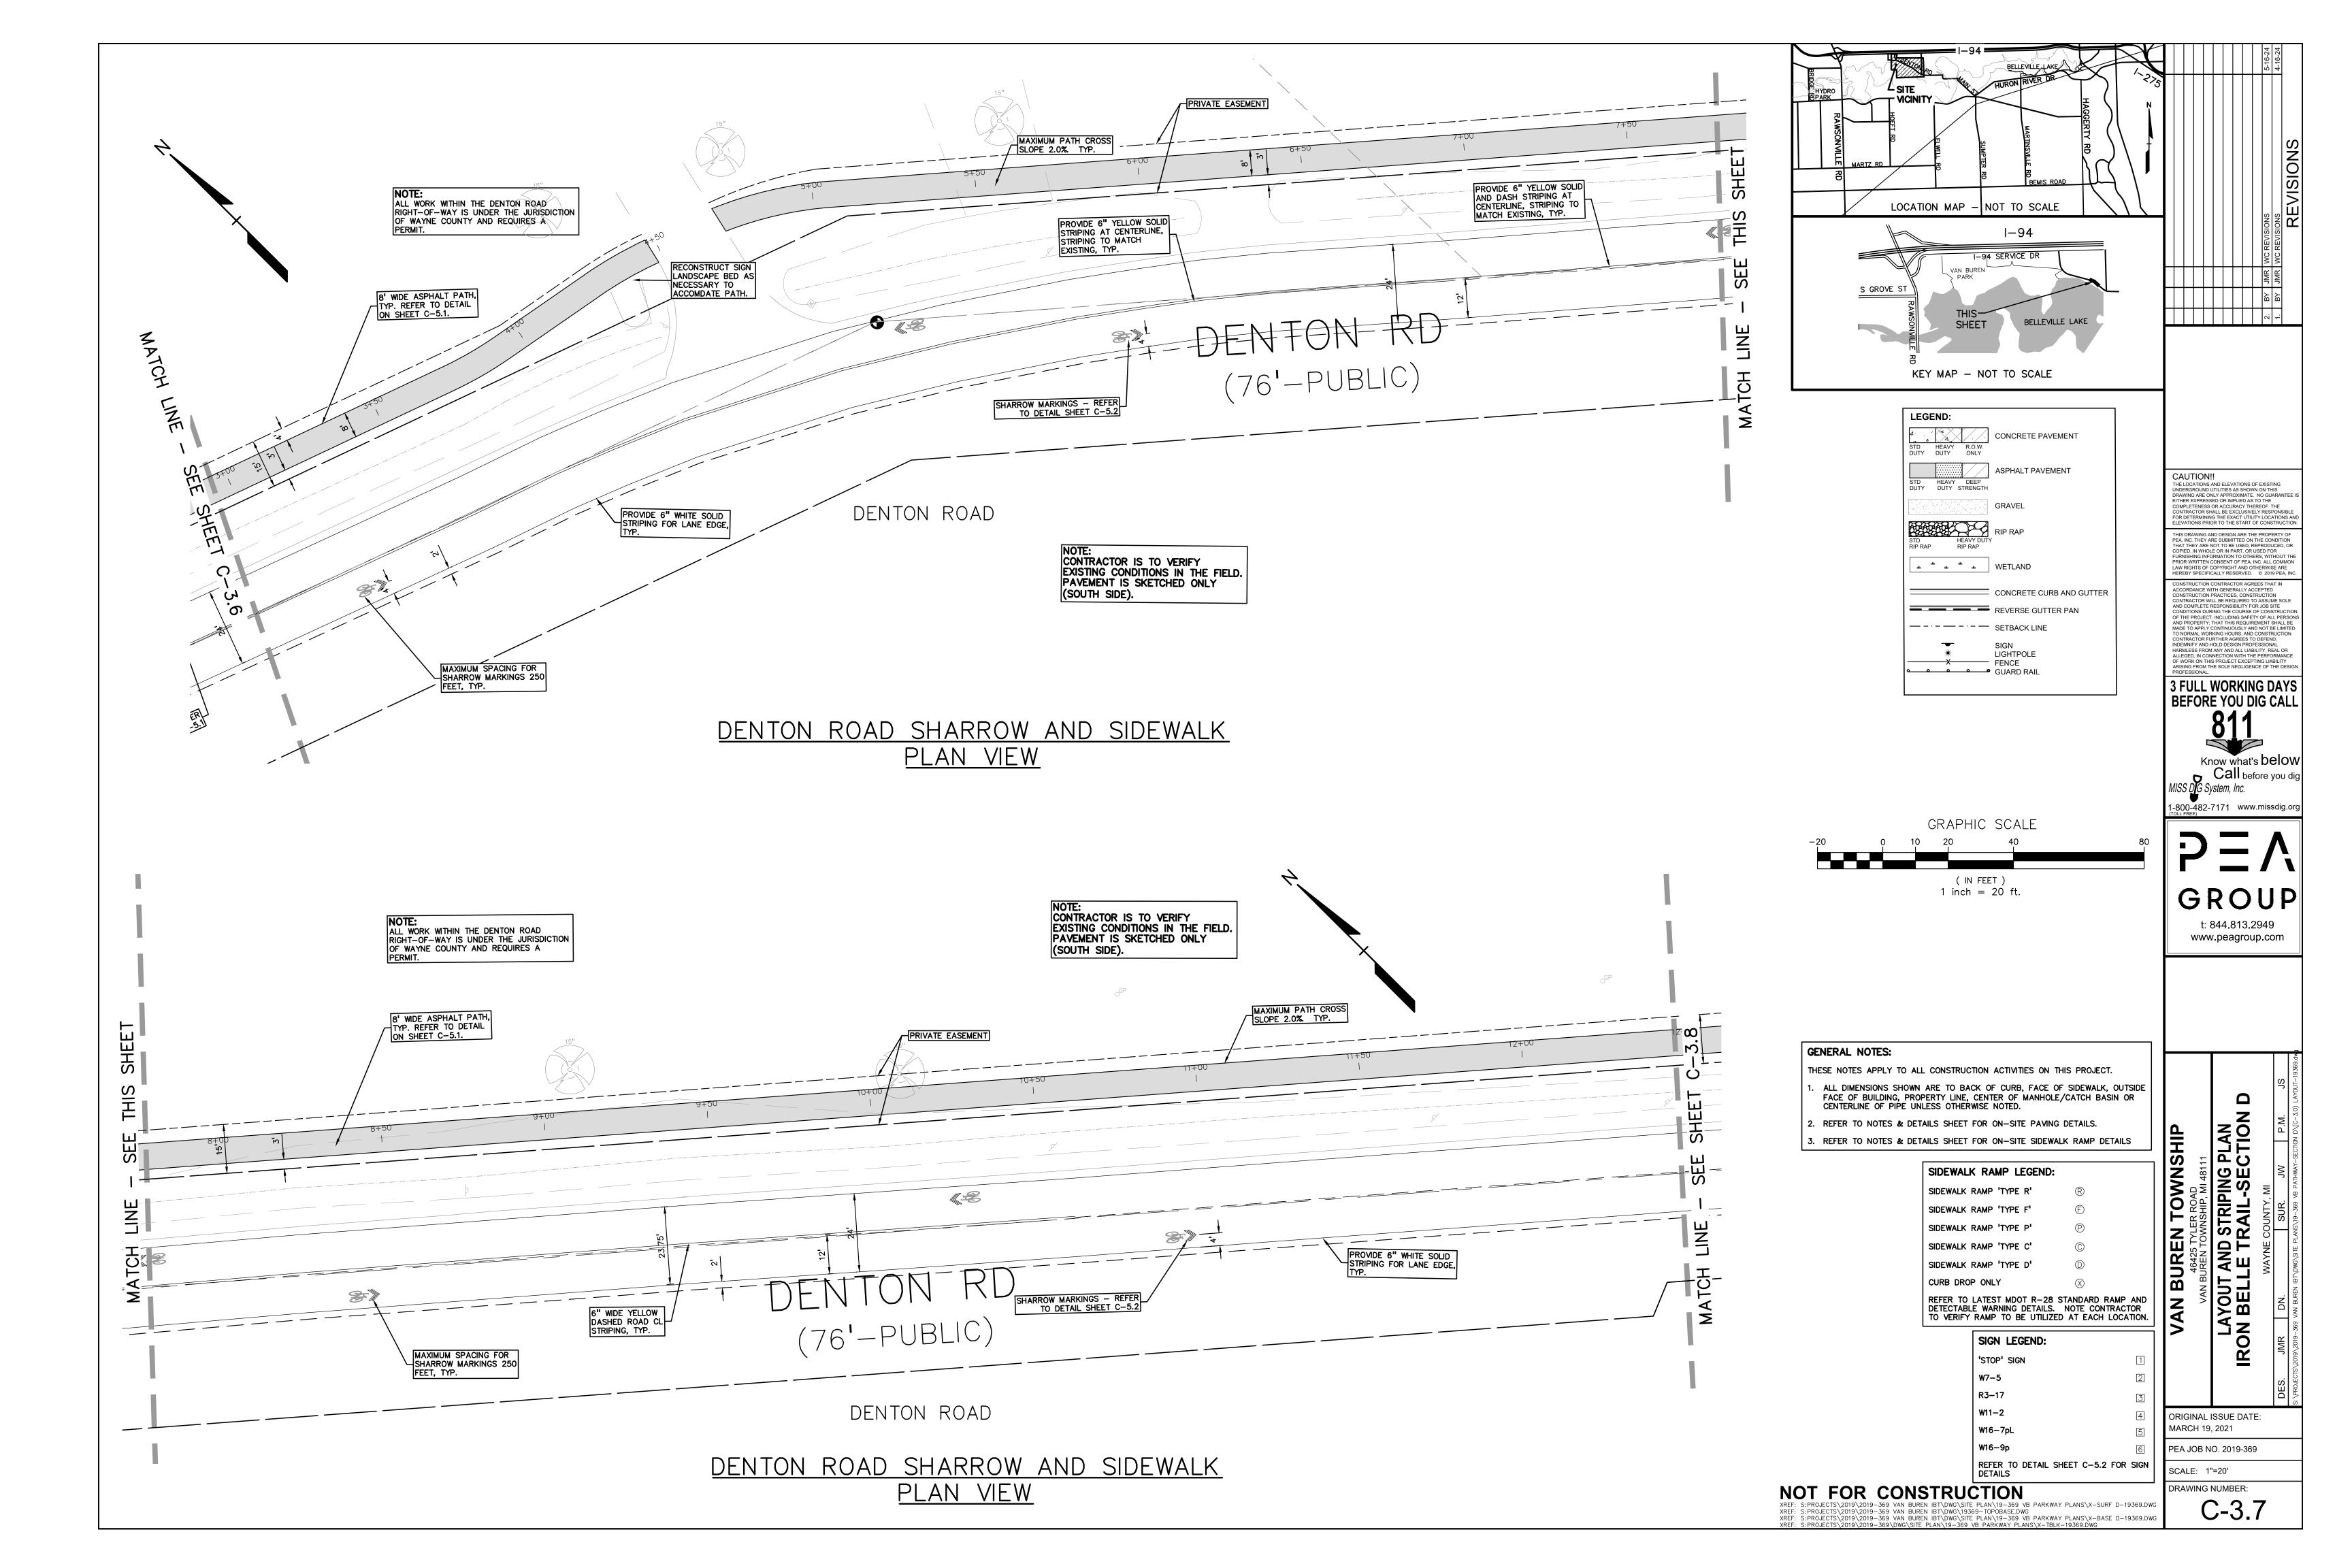

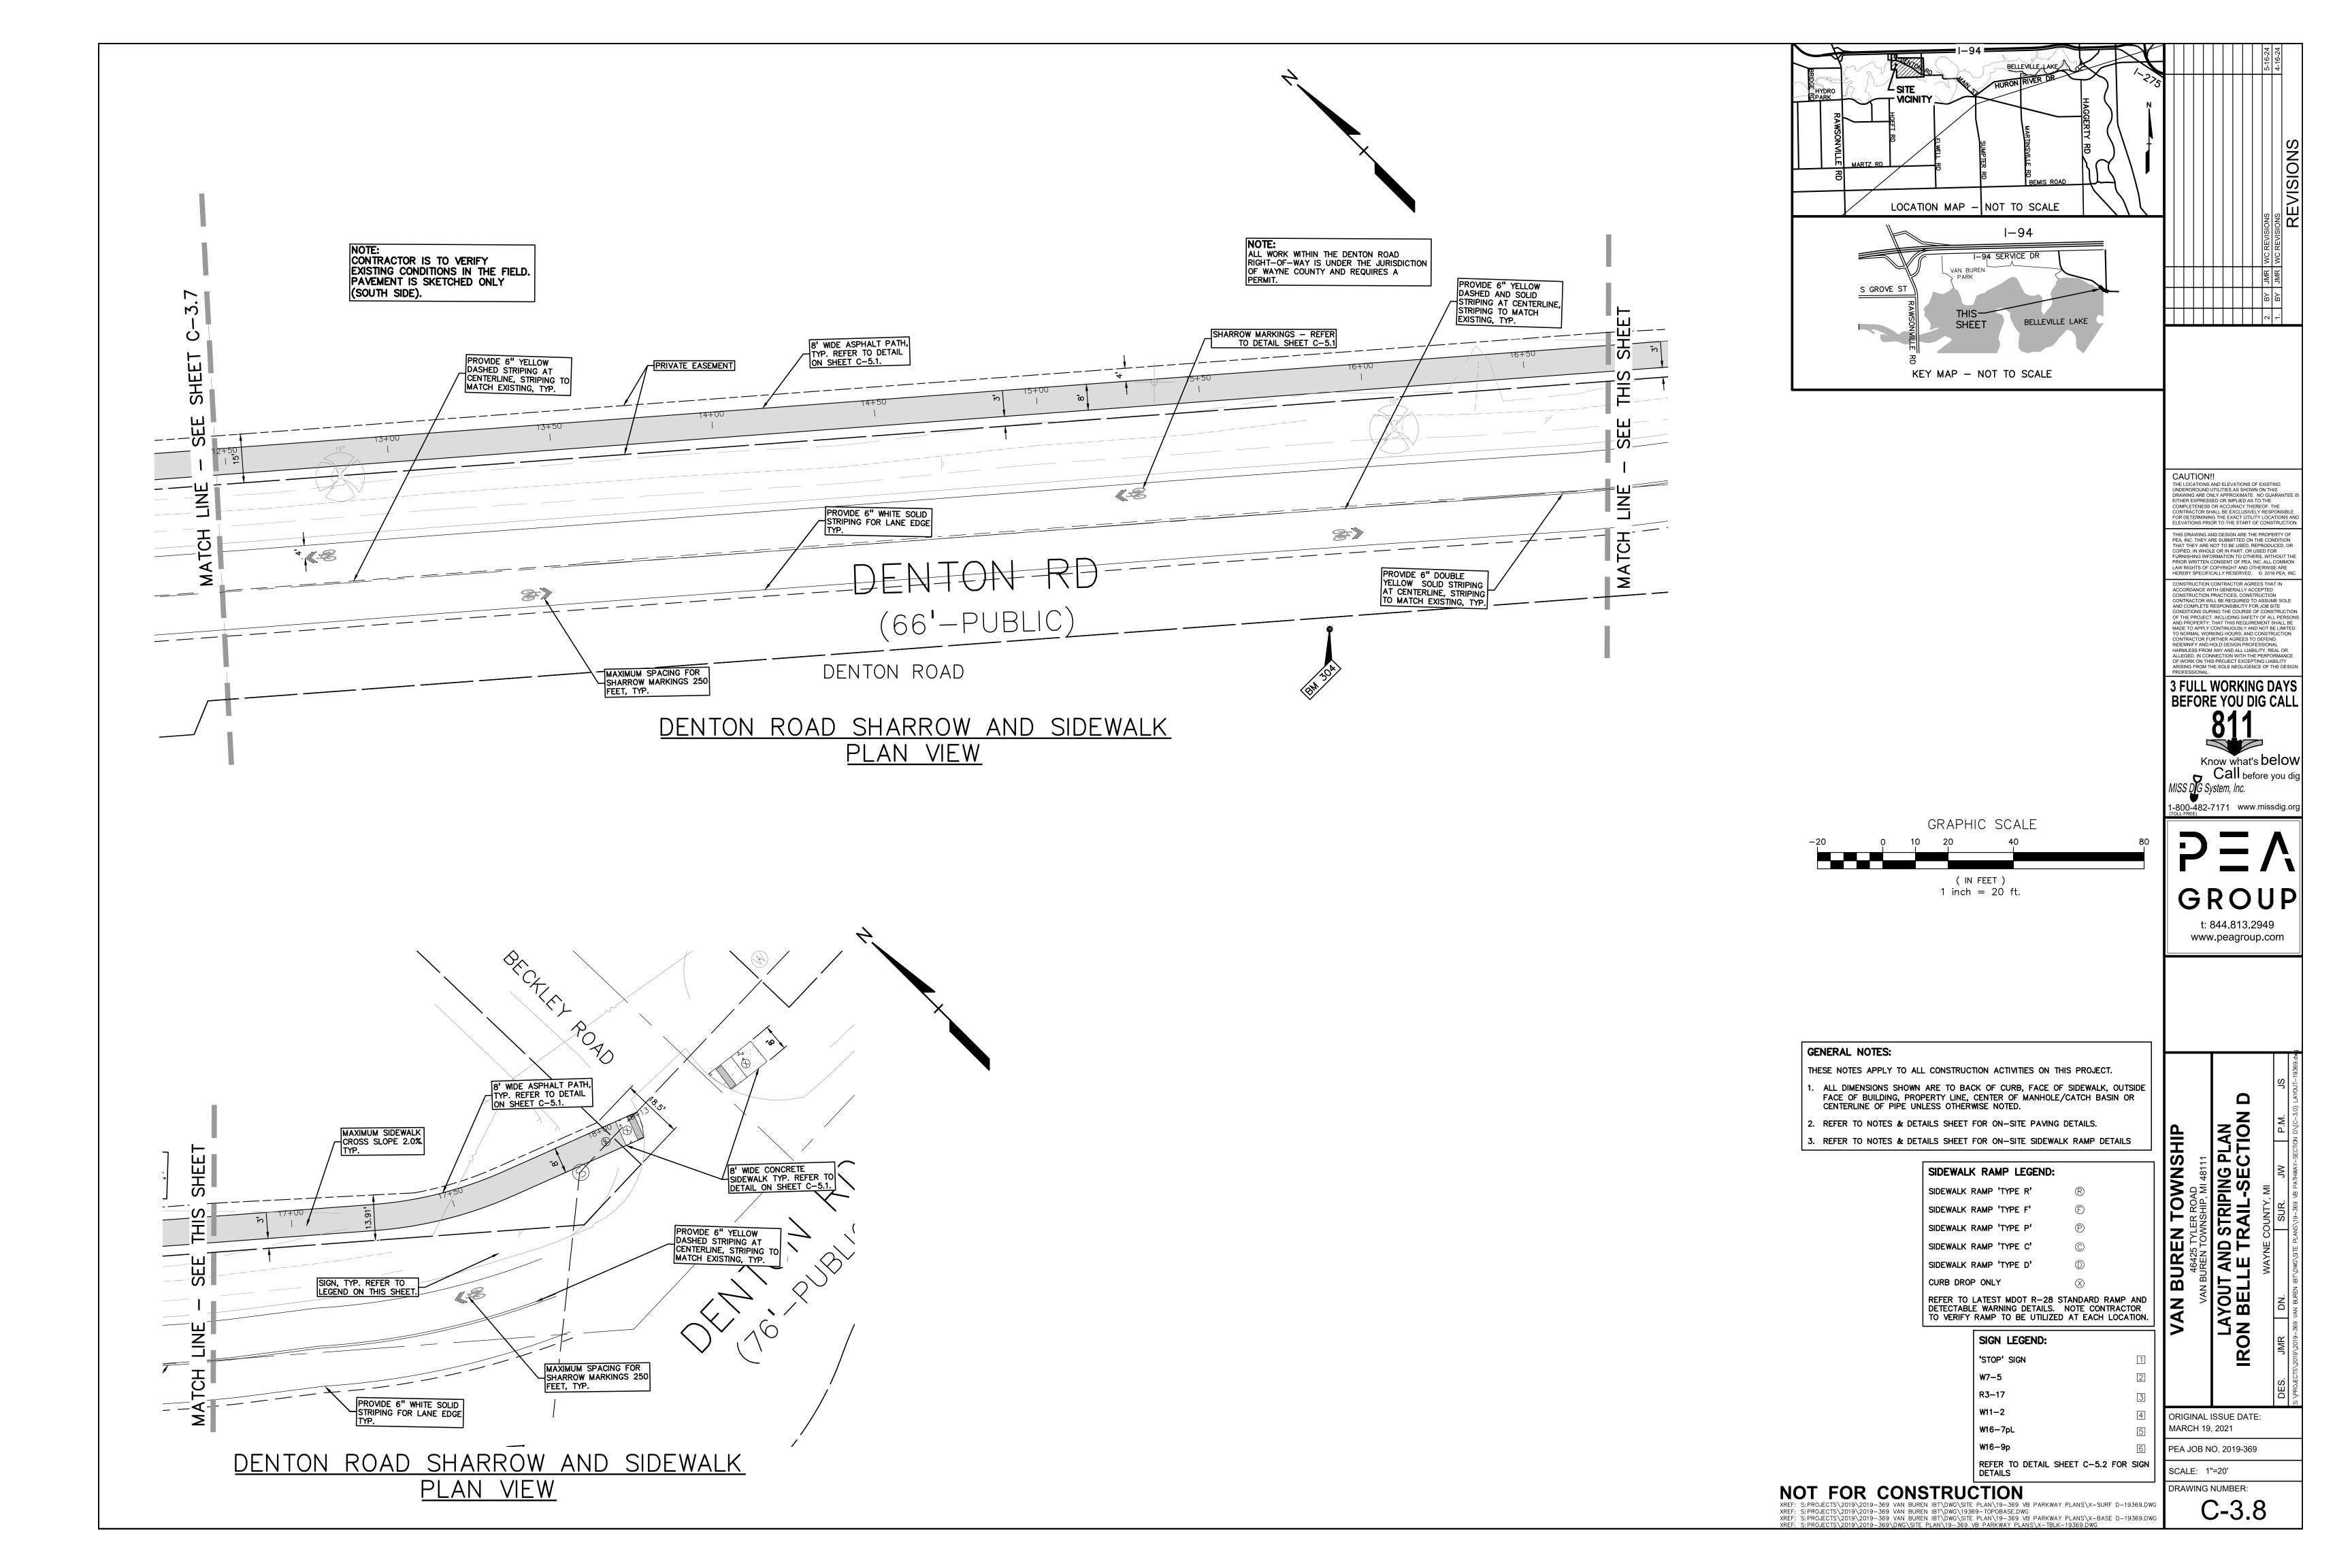

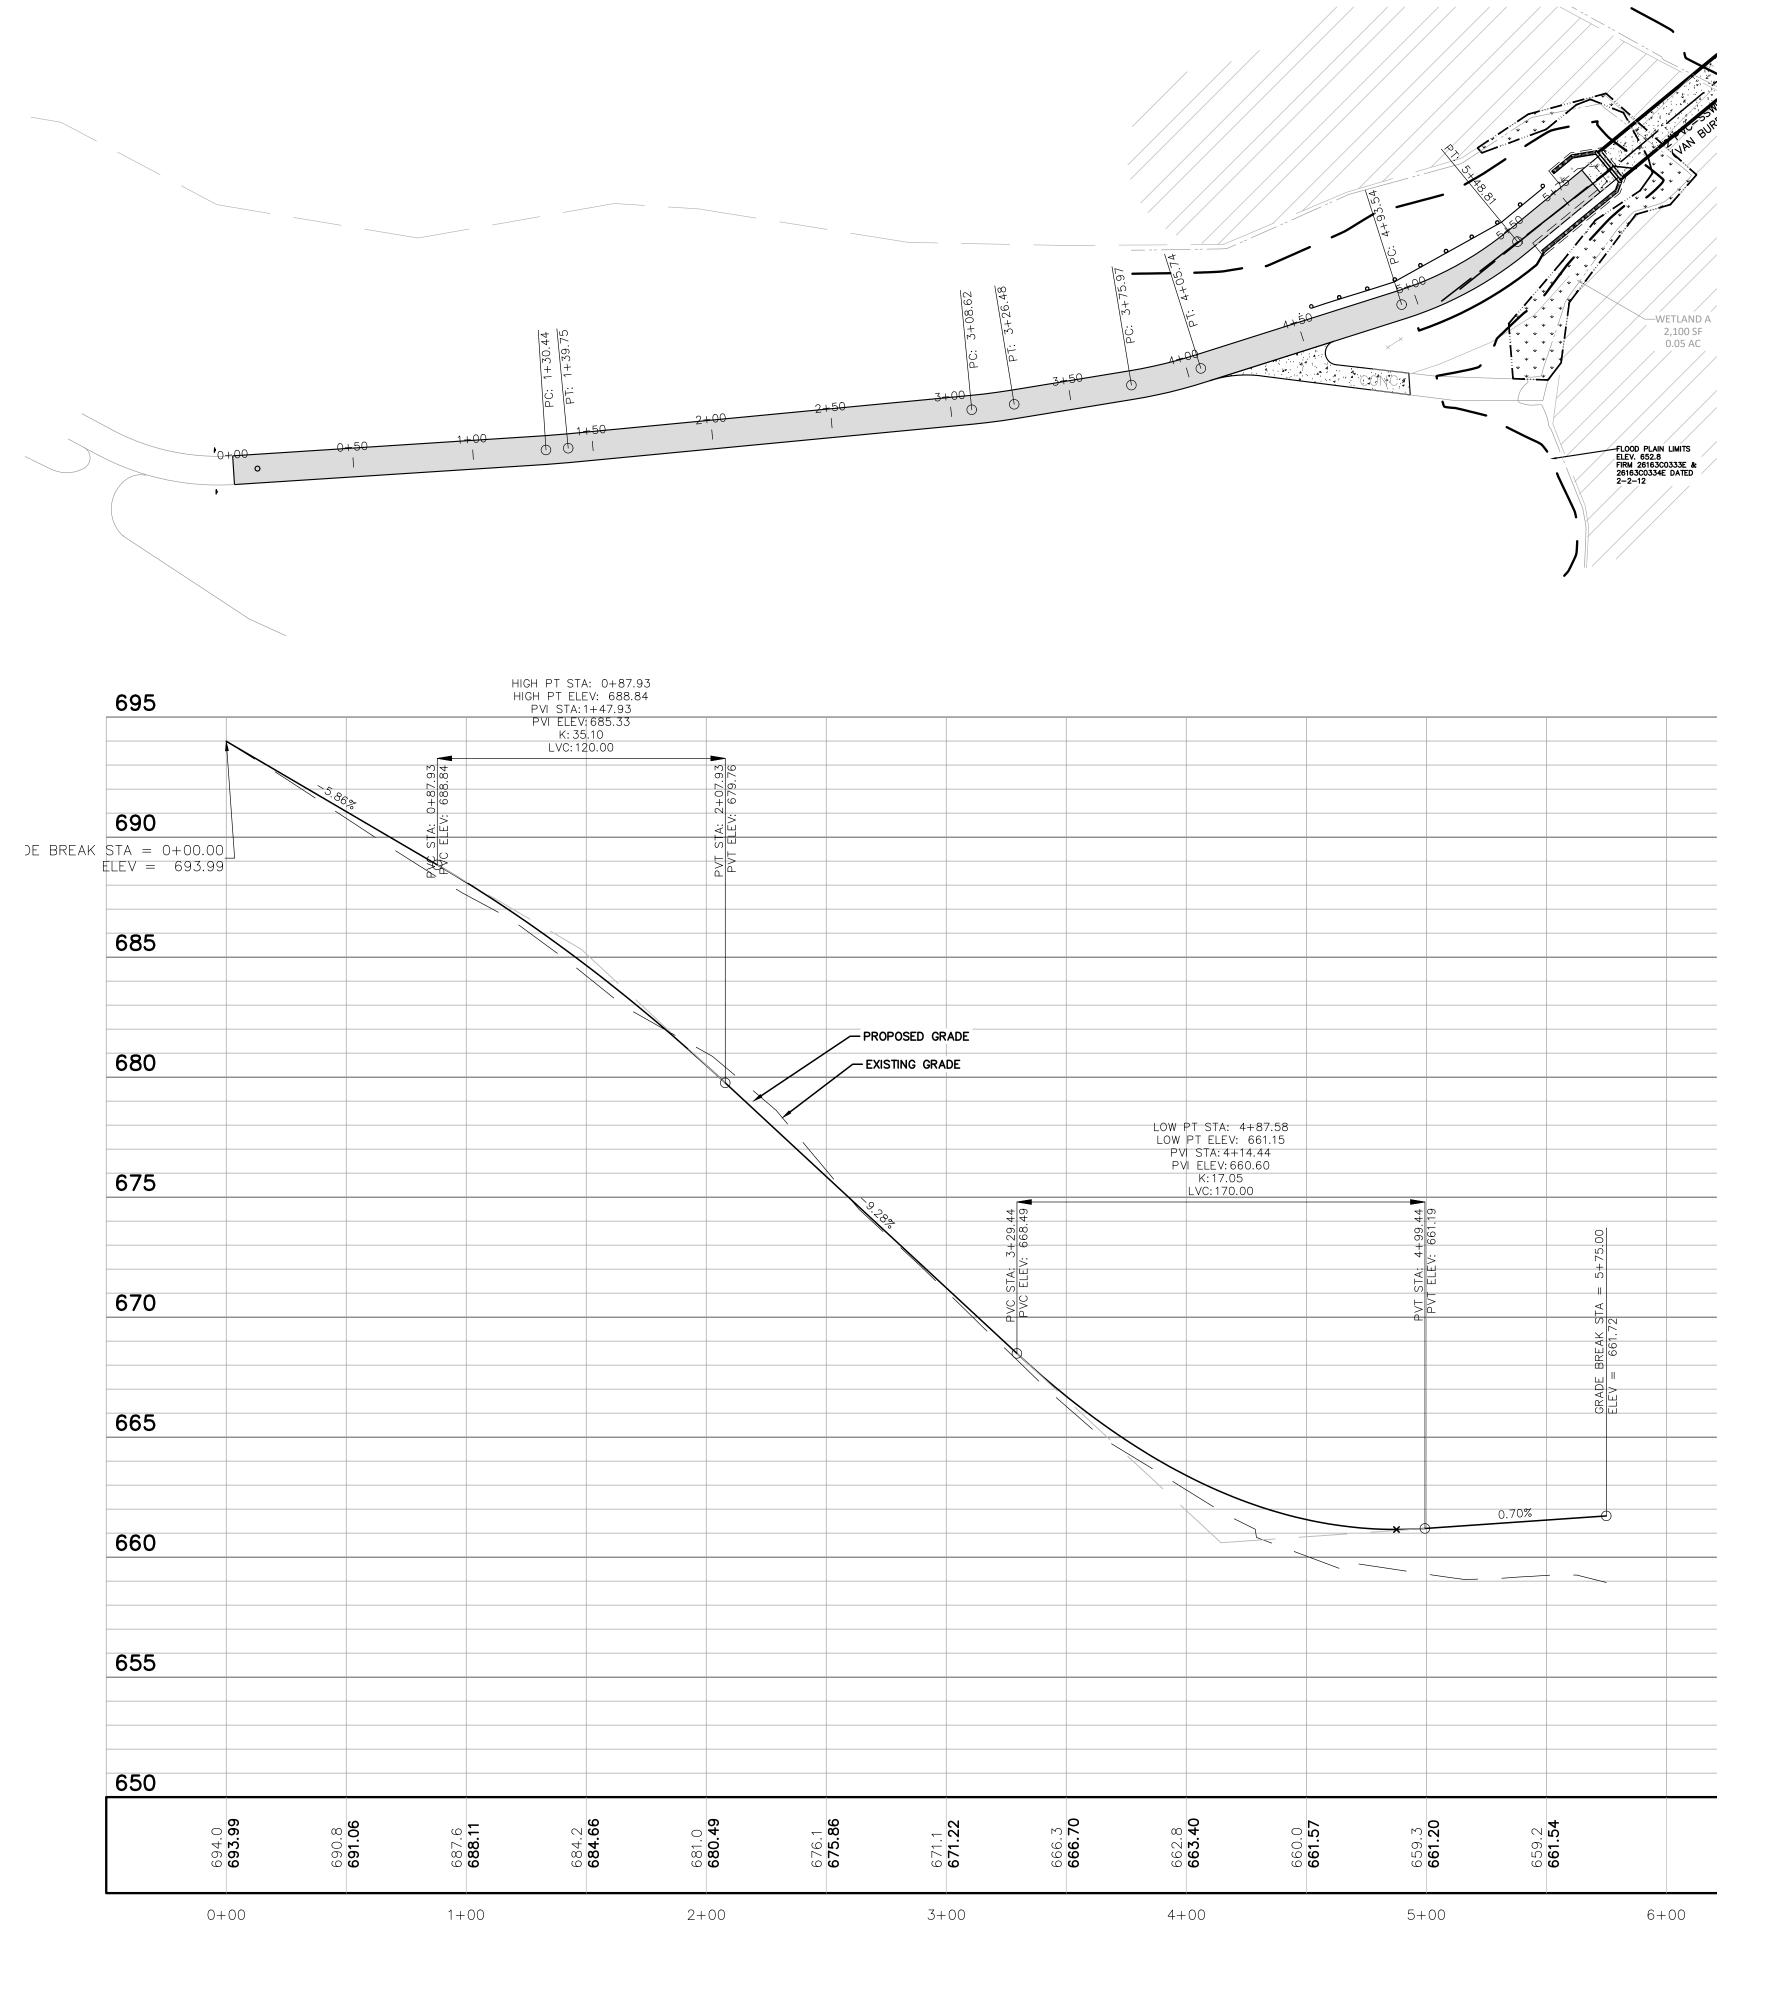

GENERAL GRADING AND EARTHWORK NOTES:


THESE NOTES APPLY TO ALL CONSTRUCTION ACTIVITIES ON THIS PROJECT


- CONTRACTOR SHALL FIELD VERIFY ALL EXISTING TREES AND BRUSH AND REMOVE ALL THAT ARE NECESSARY TO GRADE SITE.
- 2. ALL GRADES ARE TO TOP OF PAVEMENT UNLESS OTHERWISE NOTED.
- RESPONSIBILITY AND RISK OF THE CONTRACTOR.

CONSTRUCTION ACTIVITIES OUTSIDE OF THE SITE BOUNDARIES SHALL BE AT THE SOLE

THE STAGING OF CONSTRUCTION ACTIVITIES SHALL OCCUR ONLY WITHIN THE SITE BOUNDARIES. ANY

- ALL SOIL EROSION AND SEDIMENTATION CONTROL MEASURES SHALL MEET THE REQUIREMENTS OF THE AUTHORIZED PUBLIC AGENCY OF JURISDICTION. AN EROSION CONTROL PERMIT MUST BE SECURED FROM THE WAYNE COUNTY PRIOR TO CONSTRUCTION.
- 5. ALL EARTHWORK AND GRADING OPERATIONS SHALL BE PERFORMED IN ACCORDANCE WITH THE SOILS INVESTIGATION AND REPORT.
- REFER TO SOIL EROSION CONTROL PLAN FOR ADDITIONAL SOIL EROSION AND SEDIMENTATION CONTROL MEASURES AND NOTES.
- ALL DISTURBED AREAS SHALL BE SEEDED AND BLANKETED IN ACCORDANCE WITH THESE PLANS. PROVIDE A MINIMUM OF 3" OF TOPSOIL IN THESE AREAS UNLESS OTHERWISE NOTED.
- 8. THE CONTRACTOR SHALL NOTE EXISTING UNDERGROUND UTILITIES WITHIN AND ADJACENT TO THE SITE. BACKFILL FOR EXISTING UTILITY TRENCHES SHALL BE EXAMINED CRITICALLY. ANY TRENCHES FOUND TO HAVE SOFT, UNSTABLE OR UNSUITABLE BACKFILL MATERIAL, IN THE OPINION OF THE THIRD PARTY TESTING COMPANY, THAT ARE TO BE WITHIN THE ZONE OF INFLUENCE OF PROPOSED BUILDINGS OR PAVEMENT SHALL BE COMPLETELY EXCAVATED AND BACKFILLED WITH SUITABLE
- ON-SITE FILL CAN BE USED IF THE SPECIFIED COMPACTION REQUIREMENTS CAN BE ACHIEVED. IF ON-SITE SOIL IS USED, IT SHOULD BE CLEAN AND FREE OF FROZEN SOIL, ORGANICS, OR OTHER
- 10. THE FINAL SUBGRADE/EXISTING AGGREGATE BASE SHOULD BE THOROUGHLY PROOFROLLED USING A FULLY LOADED TANDEM AXLE TRUCK OR FRONT END LOADER UNDER THE OBSERVATION OF A GEOTECHNICAL/PAVEMENT ENGINEER. LOOSE OR YIELDING AREAS THAT CANNOT BE MECHANICALLY STABILIZED SHOULD BE REINFORCED USING GEOGRIDS OR REMOVED AND REPLACED WITH ENGINEERED FILL OR AS DICTATED BY FIELD CONDITIONS.
- . SUBGRADE UNDERCUTTING, INCLUDING BACKFILLING SHALL BE PERFORMED TO REPLACE MATERIALS SUSCEPTIBLE TO FROST HEAVING AND UNSTABLE SOIL CONDITIONS. ANY EXCAVATIONS THAT MAY BE REQUIRED BELOW THE TOPSOIL IN FILL AREAS OR BELOW PROPOSED SUBGRADE IN CUT AREAS WILL BE CLASSIFIED AS SUBGRADE UNDERCUTTING.
- 12. SUBGRADE UNDERCUTTING SHALL BE PERFORMED WHERE NECESSARY AND THE EXCAVATED MATERIAL SHALL BECOME THE PROPERTY OF THE CONTRACTOR. ANY SUBGRADE UNDERCUTTING SHALL BE BACKFILLED AS RECOMMENDED IN THE GEOTECHNICAL ENGINEERING REPORT FOR THE
- 13. ANY SUBGRADE WATERING REQUIRED TO ACHIEVE REQUIRED DENSITY SHALL BE CONSIDERED INCIDENTAL TO THE JOB.

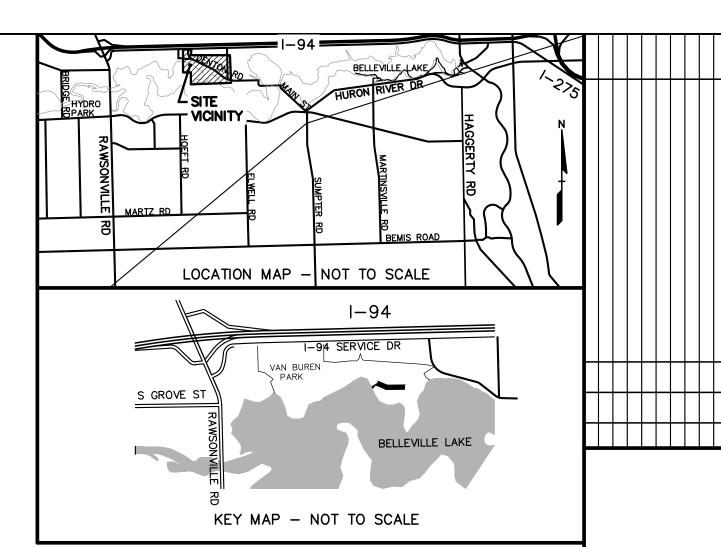

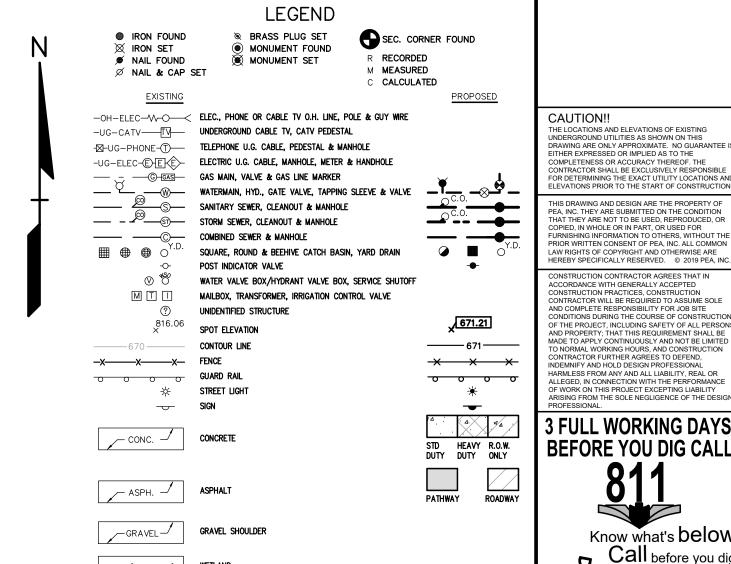

GRAPHIC SCALE (IN FEET) 1 inch = 40 ft.

EARTHWORK BALANCING NOTE:

THE CONTRACTOR SHALL BE RESPONSIBLE FOR IMPORTING OR EXPORTING ALL MATERIALS AS REQUIRED TO PROPERLY GRADE THIS PROJECT TO THE FINISHED ELEVATIONS SHOWN ON THE APPROVED PLANS. THE CONTRACTOR SHALL MAKE THEIR OWN DETERMINATION OF CUT AND FILL QUANTITIES AND ALLOW FOR REMOVAL OF EXCESS OR IMPORTATION OF ADDITIONAL MATERIAL AT NO ADDITIONAL COST TO THE OWNER.

> **BENCHMARKS** (GPS DERIVED - NAVD 88)

BM #309
1/2" IRON ROD WITH CAP. 10' SOUTH OF
CENTER LINE OF VAN BUREN PARK ROAD
AND 256 NORTHWEST OF NORTHWEST OF BUILDING CORNER. ELEV.- 698.59

_{(Ш}, О VAN BUREN TOWNSHIP

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ORIGINAL ISSUE DATE: MARCH 19, 2021

PEA JOB NO. 2019-369


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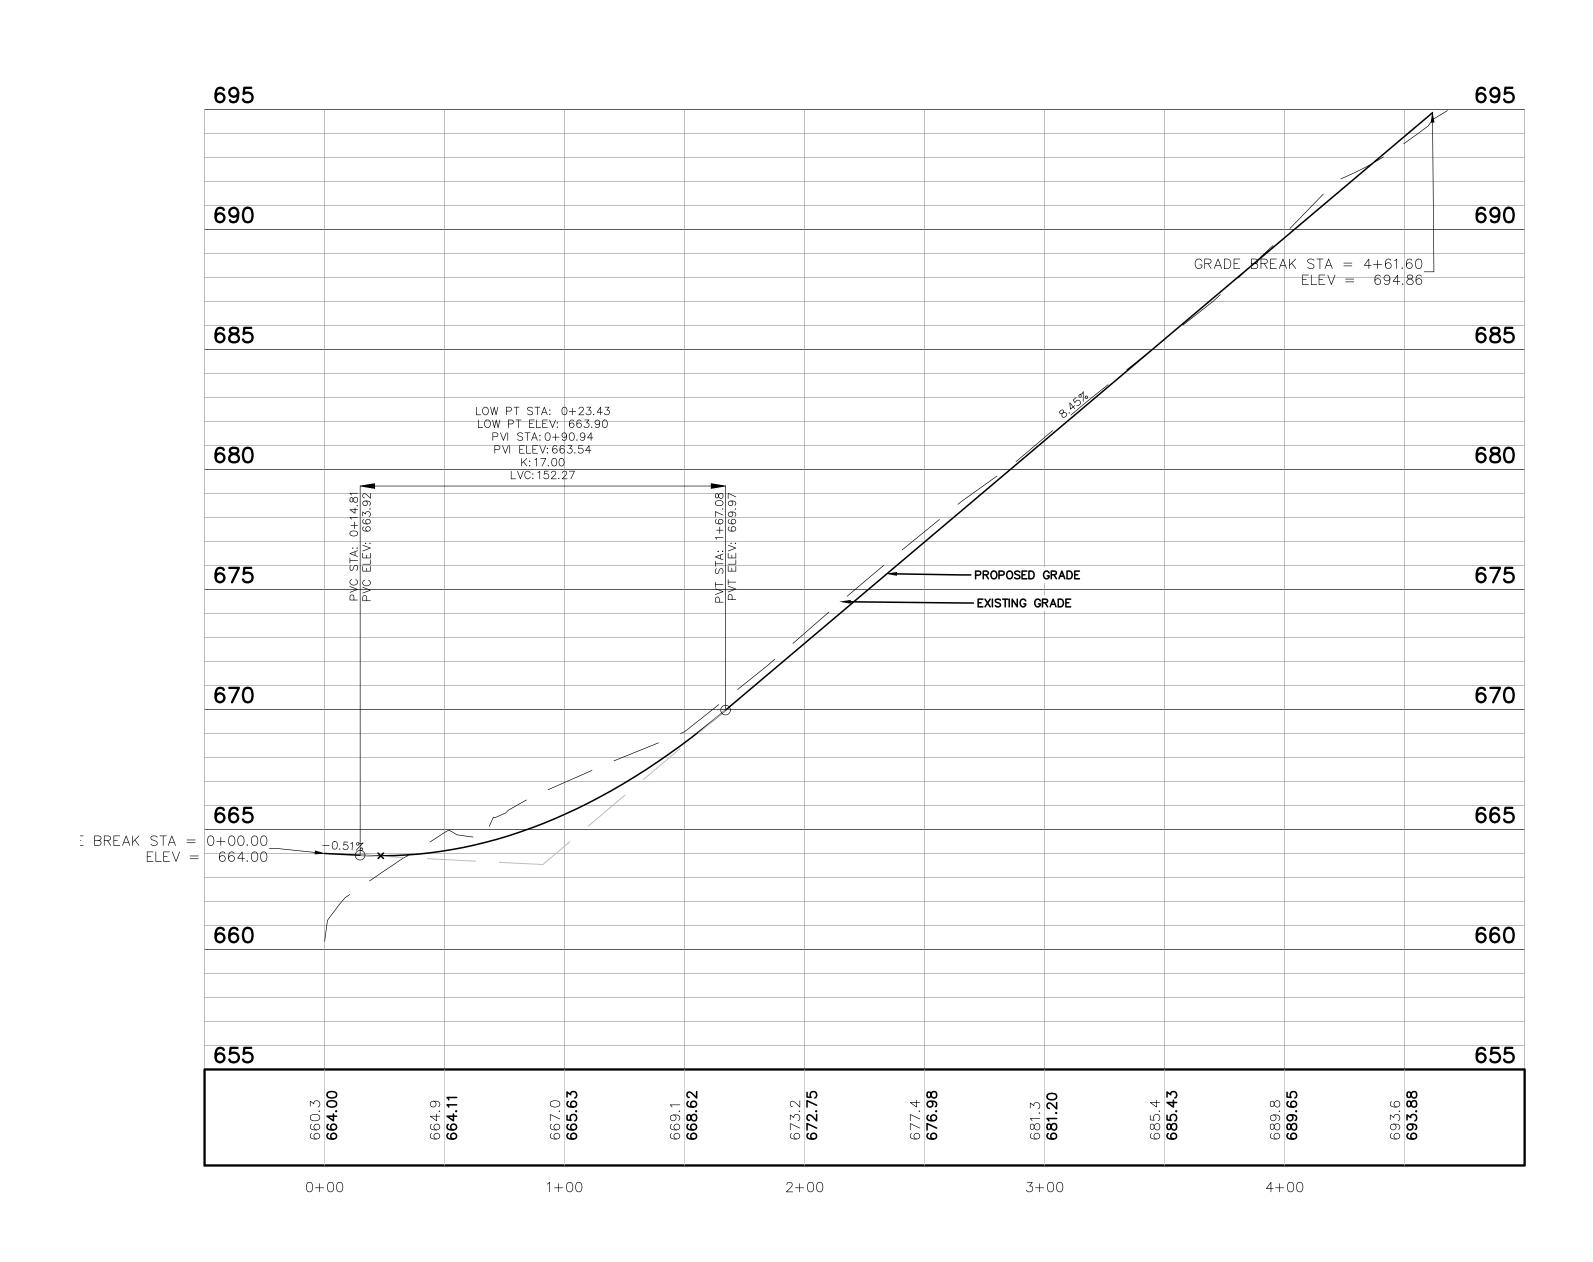
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TRAIL PLAN VIEW


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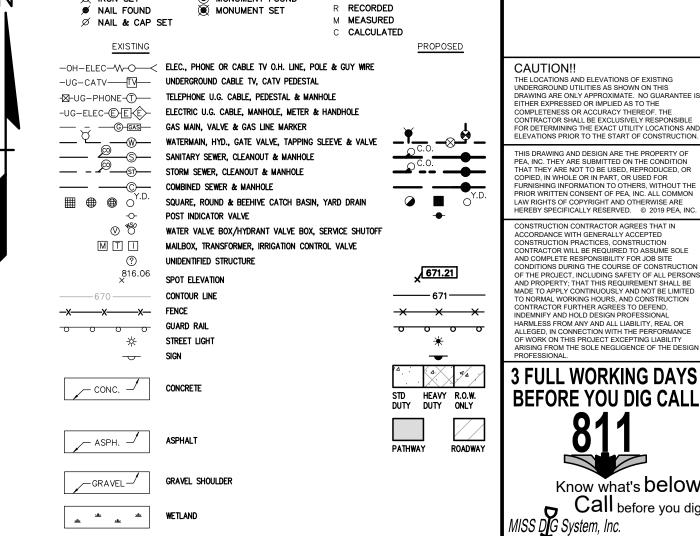
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XREF: S:PROJECTS\2019\2019-369\DWG\SITE PLAN\19-369 VB PARKWAY PLANS\X-TBLK-19369.DWG





TRAIL PLAN VIEW

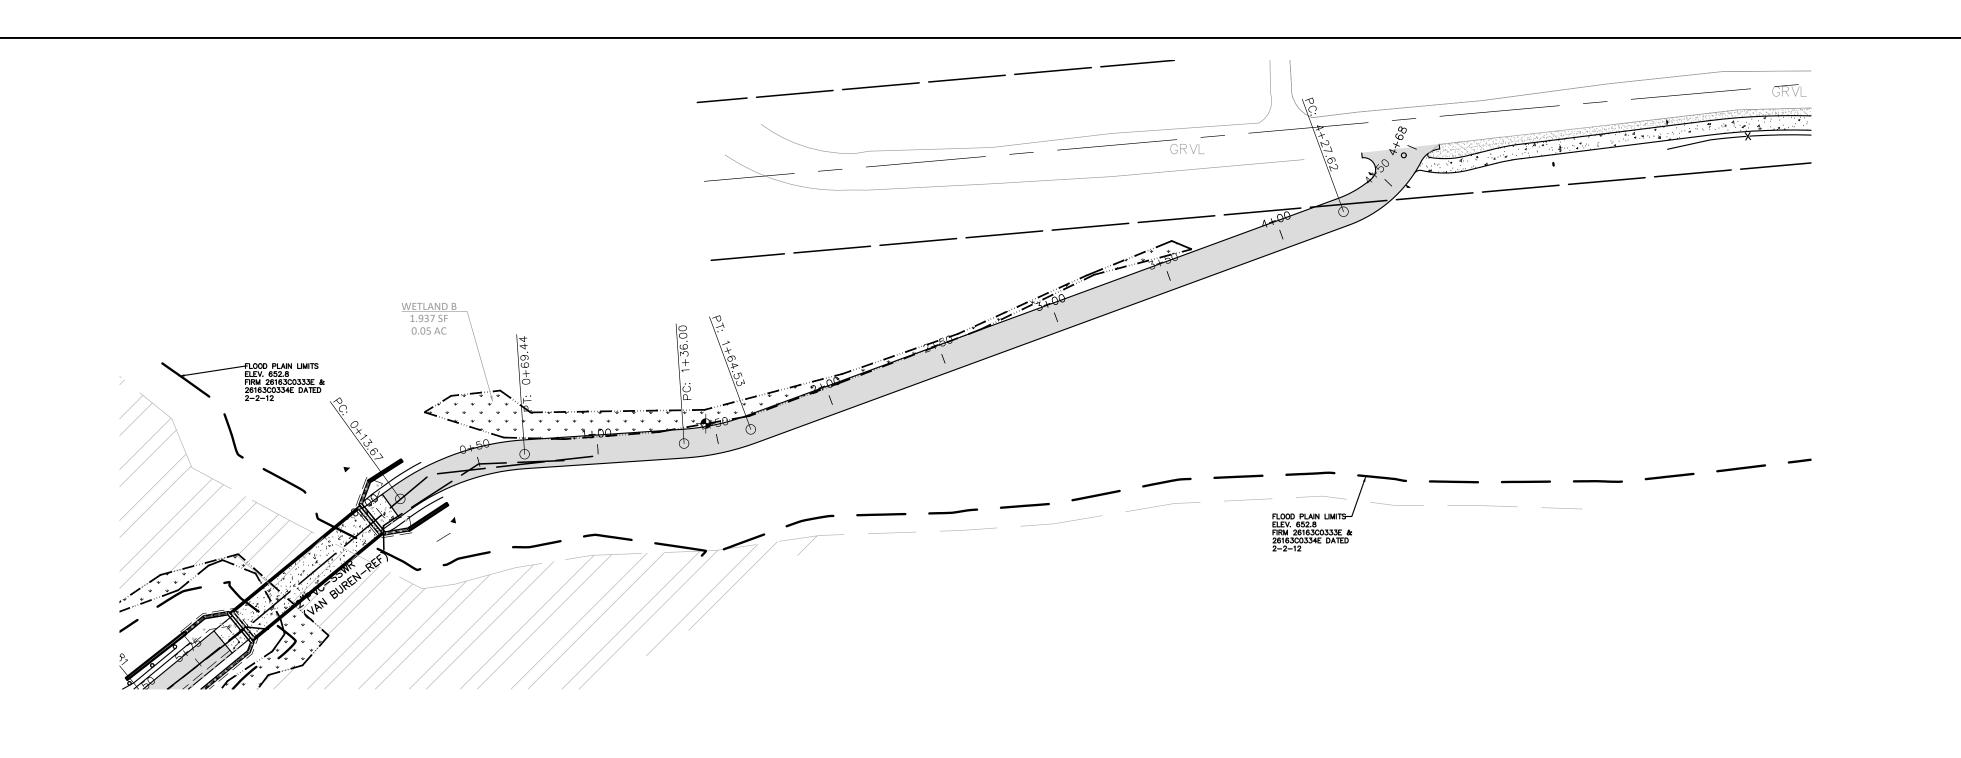

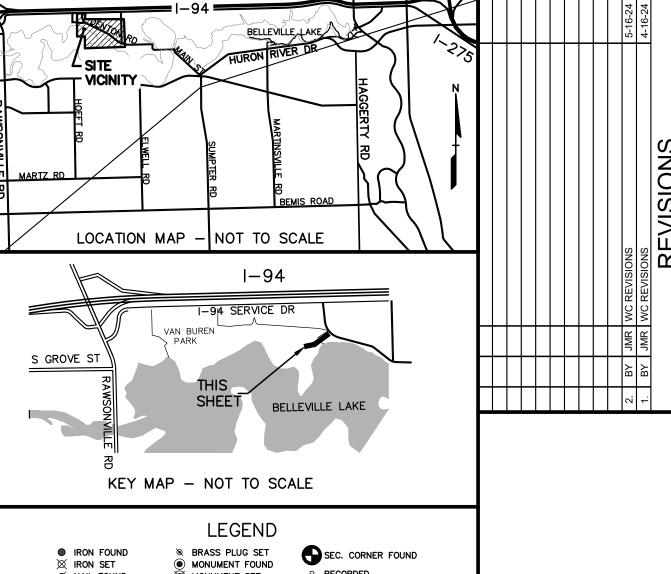

(IN FEET) 1 inch = 40 ft.

EARTHWORK BALANCING NOTE:

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GRAPHIC SCALE

BENCHMARKS (GPS DERIVED - NAVD 88) BM #309
1/2" IRON ROD WITH CAP. 10' SOUTH OF
CENTER LINE OF VAN BUREN PARK ROAD
AND 256 NORTHWEST OF NORTHWEST OF
BUILDING CORNER.
ELEV.— 698.59 VAN BUREN TOWNSHIP
46425 TYLER ROAD

CAUTION!!

THE LOCATIONS AND ELEVATIONS OF EXISTING UNDERGROUND UTILITIES AS SHOWN ON THIS DRAWING ARE ONLY APPROXIMATE. NO GUARANTEE EITHER EXPRESSED OR IMPLIED AS TO THE COMPLETENESS OR ACCURACY THEREOF. THE CONTRACTOR SHALL BE EXCLUSIVELY RESPONSIBLE FOR DETERMINING THE EXACT UTILITY LOCATIONS AS ELEVATIONS PRIOR TO THE START OF CONSTRUCTION.

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PARK PATH PLAN & PROFILE
BELLE TRAIL-SECTION D EAST RON

ORIGINAL ISSUE DATE: MARCH 19, 2021

PEA JOB NO. 2019-369

SCALE: 1"=20' DRAWING NUMBER: C-4.2

NOT FOR CONSTRUCTION

XREF: S:PROJECTS\2019\2019-369 VAN BUREN IBT\DWG\SITE PLAN\19-369 VB PARKWAY PLANS\X-SURF D-19369.DWG

XREF: S:PROJECTS\2019\2019-369 VAN BUREN IBT\DWG\19369-TOPOBASE.DWG

XREF: S:PROJECTS\2019\2019-369 VAN BUREN IBT\DWG\SITE PLAN\19-369 VB PARKWAY PLANS\X-BASE D-19369.DWG

XREF: S:PROJECTS\2019\2019-369\DWG\SITE PLAN\19-369 VB PARKWAY PLANS\X-TBLK-19369.DWG

SEQUENCE OF CONSTRUCTION:

START DAY END DAY
1 5 INSTALL CRUSHED CONCRETE ACCESS APPROACH AT LOCATIONS PER PLAN.

1 5 INSTALL TEMPORARY SOIL EROSION CONTROL MEASURES, SILT FENCES, INLET PROTECTION, ETC. AS NECESSARY.

1 120 MAINTAIN A 25' BUFFER OF VEGETATION AROUND PERIMETER OF SITE WHERE POSSIBLE.

5 25 REMOVE ALL VEGETATION, TREES AND BRUSH FROM THE PROPOSED CONSTRUCTION AREA UNLESS MARKED TO REMAIN. STRIP AND STOCKPILE TOPSOIL AS REQUIRED RESTORATION. ALL STOCKPILES MUST BE GRADED AND SEEDED.

5 25 REMOVE ALL PAVEMENT, CURB, UTILITIES, ETC. AS REQUIRED TO INSTALL THE PROPOSED WORK AS SHOWN ON THE TOPOGRAPHIC SURVEY AND DEMOLITION PLAN.

5 25 DISPOSE OF ALL EXCESS/UNSUITABLE MATERIALS OFF SITE IN A LEGAL MANNER. NO ON-SITE BURN OR BURY PITS ALLOWED.

25 45 ROUGH GRADE SITE. SEED AND MULCH BLANKETS MUST BE INSTALLED AS SHOWN WITHIN 5 DAYS OF FINAL GRADE. REPAIR AND/OR RE-INSTALL ANY TEMPORARY SOIL EROSION CONTROL MEASURES THAT WERE DAMAGED DURING GRADING OPERATIONS.

45 60 INSTALL SITE UTILITIES (DRAIN TILE) AND RETAINING WALLS. INSTALL RIP RAP AT END SECTION.

60 90 GRADE SITE AND PREPARE FOR SITE PAVING OPERATIONS.

90 110 INSTALL ALL PAVEMENT, SIDEWALKS, CURBING AS PROPOSED. IF PERMANENT LANDSCAPING IS NOT TO BE INSTALLED SOON AFTER PAVING IS COMPLETE, ALL AREAS WITHIN 20 FEET OF BACK OF CURB MUST BE TEMPORARILY SEEDED. REPAIR INLET PROTECTION, SILT FENCE AND ANY OTHER DAMAGED SOIL EROSION CONTROL MEASURES AS NECESSARY.

25 90 TEMPORARY SEEDING MUST BE PROVIDED IN AREAS NOT TO BE WORKED ON FOR 15 DAYS OR LONGER.

90 110 FINAL GRADE, REDISTRIBUTE STOCKPILED TOPSOIL, ESTABLISH VEGETATION AND INSTALL ALL PERMANENT LANDSCAPING IN ALL DISTURBED AREAS NOT BUILT.

110 120 CLEAN PAVEMENT AND REMOVE ALL TEMPORARY SOIL EROSION CONTROL MEASURES. RE-ESTABLISH VEGETATION AS REQUIRED. 120 120 REMOVE SEDIMENTATION CONTROLS ONCE ENTIRE SITE HAS BEEN PERMANENTLY STABILIZED.

SOIL EROSION MAINTENANCE SCHEDULE AND NOTES:

THE CONTRACTOR SHALL INSPECT THE SOIL EROSION AND SEDIMENTATION CONTROL DEVICES ONCE EACH WEEK AND/OR WITHIN 24 HOURS OF A RAINFALL EVENT WHICH RESULTS IN A STORM WATER DISCHARGE FROM THE SITE. THE FOLLOWING STEPS SHALL BE IMPLEMENTED I ANY DAMAGE HAS OCCURRED.

ANY DEBRIS OR DIRT ON ANY PAVED AREA RESULTING FROM CONSTRUCTION TRAFFIC SHALL BE CLEANED IN A PROMPT MANNER BY THE CONTRACTOR. THE CONSTRUCTION DRIVE SHALL BE CLEANED AT THE END OF EACH DAY.

2. ALL DIRT AND MUD TRACKED ONTO PAVED AREAS SHALL BE REMOVED DAILY BY SCRAPING. STREET SWEEPING IS REQUIRED WEEKLY.

3. SILT FENCE MAINTENANCE SHALL INCLUDE THE REMOVAL OF ANY BUILT UP SEDIMENT WHEN THE SEDIMENT HEIGHT ACCUMULATES TO 1/3 TO 1/2 OF THE HEIGHT OF THE FENCE. THE CONTRACTOR IS RESPONSIBLE TO REMOVE, REPLACE, RETRENCH OR REBACKFILL THE SILTATION FENCE SHOULD IT FALL OR BE DAMAGED DURING

. INLET FILTER MAINTENANCE SHALL INCLUDE THE REMOVAL OF ANY ACCUMULATED SILT OR OTHER DEBRIS. THE REMOVAL OF SILT SHOULD BE WITH THE USE OF A STIFF BRISTLE BROOM OR SQUARE POINT SHOVEL. IF INLET FILTERS CAN NOT BE CLEANED OR ARE DAMAGED, THEN THE FABRIC MUST BE REPLACED.

A WATER TRUCK SHALL BE AVAILABLE TO WATER DOWN THE SITE ON A DAILY BASIS AS REQUIRED TO MAINTAIN DUST CONTROL.

STREET CLEANING SCHEDULE								
	SUNDAY	MONDAY	TUESDAY	WEDNESDAY	THURSDAY	FRIDAY	SATURDAY	
SCRAPE STREETS		×	×	×	×	×	×	
SWEEP STREETS				×				

GENERAL SITE CONDITIONS:

PER THE USGS SOIL SURVEY, THE AREA OF CONSTRUCTION CONSISTS OF BOYER LOAMY SAND. 0-6 PERCENT SLOPES (Bnb) AND SPINKS LOAMY SAND, 0-6 PERCENT SLOPES (SpB). SEE THE GEOTECHNICAL INVESTIGATION PERFORMED BY PEA, INC DATED 10-31-2019 FOR FURTHER DETAILED INFORMATION.

1. TOTAL DISTURBED AREA = ± 1.9 ACRES

SOIL EROSION CONTROL NOTES:

ALL EROSION AND SEDIMENT CONTROL WORK SHALL CONFORM TO STANDARDS AND SPECIFICATIONS OF WAYNE COUNTY.


DAILY INSPECTIONS SHALL BE MADE BY THE CONTRACTOR FOR EFFECTIVENESS OF EROSION AND SEDIMENTATION CONTROL MEASURES, AND ANY REPAIRS SHALL BE PERFORMED WITHOUT


EROSION AND ANY SEDIMENTATION FROM WORK ON THIS SITE SHALL BE CONTAINED ON THE SITE AND NOT ALLOWED TO COLLECT ON ANY OFF-SITE AREAS OR IN WATERWAYS. WATERWAYS INCLUDE BOTH NATURAL AND MAN-MADE OPEN DITCHES, STREAMS, STORM DRAINS, LAKES AND PONDS.

CONTRACTOR SHALL APPLY TEMPORARY EROSION AND SEDIMENTATION CONTROL MEASURES WHEN REQUIRED AND AS DIRECTED ON THESE PLANS. REMOVE TEMPORARY MEASURES AS SOON AS PERMANENT STABILIZATION OF SLOPES, DITCHES, AND OTHER EARTH CHANGES HAVE BEEN ACCOMPLISHED AND A CERTIFICATE OF COMPLETION HAS BEEN ISSUED BY WAYNE COUNTY FOR THE SESC PERMIT.

STAGING THE WORK SHALL BE DONE BY THE CONTRACTOR AS DIRECTED IN THESE PLANS AND AS REQUIRED TO ENSURE PROGRESSIVE STABILIZATION OF DISTURBED EARTH.

SOIL EROSION CONTROL PRACTICES SHALL BE ESTABLISHED IN EARLY STAGES OF CONSTRUCTION BY THE CONTRACTOR. SEDIMENT CONTROL PRACTICES SHALL BE APPLIED AS A PERIMETER DEFENSE AGAINST ANY TRANSPORTING OF SILT OFF THE SITE.

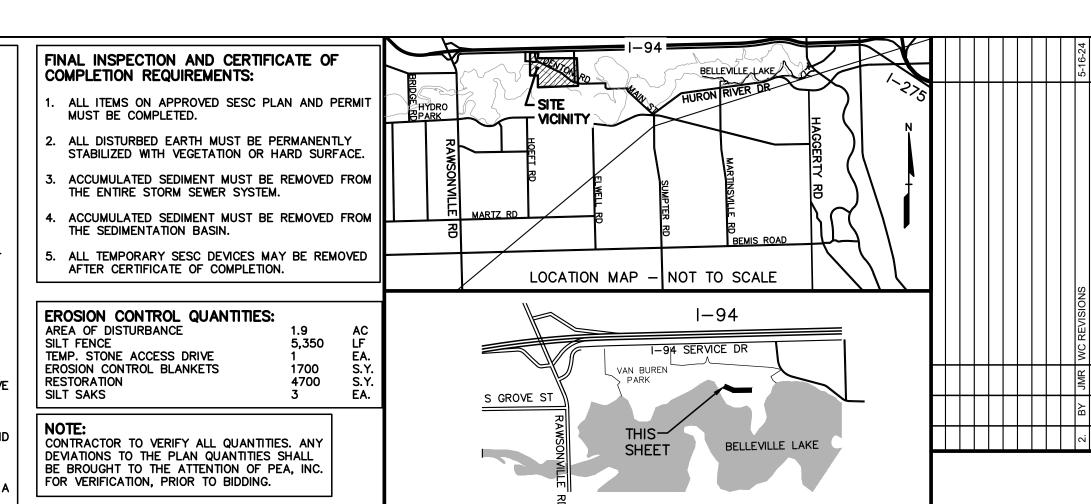

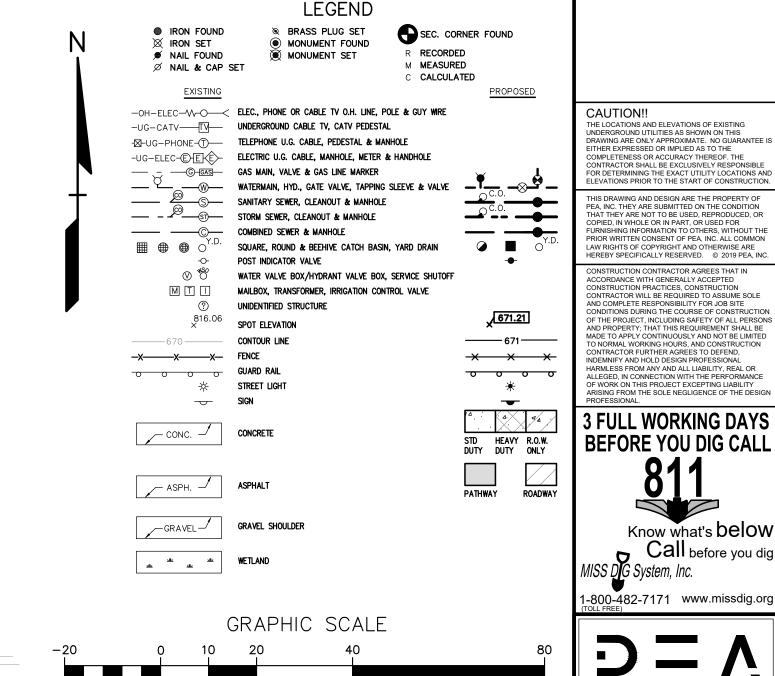

KEY MAP - NOT TO SCALE

THE CONTRACTOR SHALL BE RESPONSIBLE FOR IMPORTING OR EXPORTING ALL MATERIALS AS REQUIRED TO PROPERLY GRADE THIS PROJECT TO THE FINISHED ELEVATIONS SHOWN ON THE APPROVED PLANS. THE CONTRACTOR SHALL MAKE THEIR OWN DETERMINATION OF CUT AND FILL QUANTITIES AND ALLOW FOR REMOVAL OF EXCESS OR IMPORTATION OF ADDITIONAL MATERIAL AT NO ADDITIONAL COST TO THE OWNER.

EARTHWORK BALANCING NOTE:

1 inch = 20 ft.

BENCHMARKS (GPS DERIVED - NAVD 88) BM #309
1/2" IRON ROD WITH CAP. 10' SOUTH OF
CENTER LINE OF VAN BUREN PARK ROAD
AND 256 NORTHWEST OF NORTHWEST OF BUILDING CORNER. ELEV.- 698.59 SYMBOLS: EROSION CONTROL: SILT FENCE LOW POINT INLET FILTER RYCB INLET FILTER **EROSION CONTROL BLANKET** LIMITS OF DISTURBANCE TEMPORARY CONSTRUCTION ACCESS DRIVE (REFER TO DETAIL ON SHEET C-5.2)

NOT FOR CONSTRUCTION

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TOWNSHIP BUREN A ORIGINAL ISSUE DATE: MARCH 19, 2021 PEA JOB NO. 2019-369

SCALE: 1"=20'


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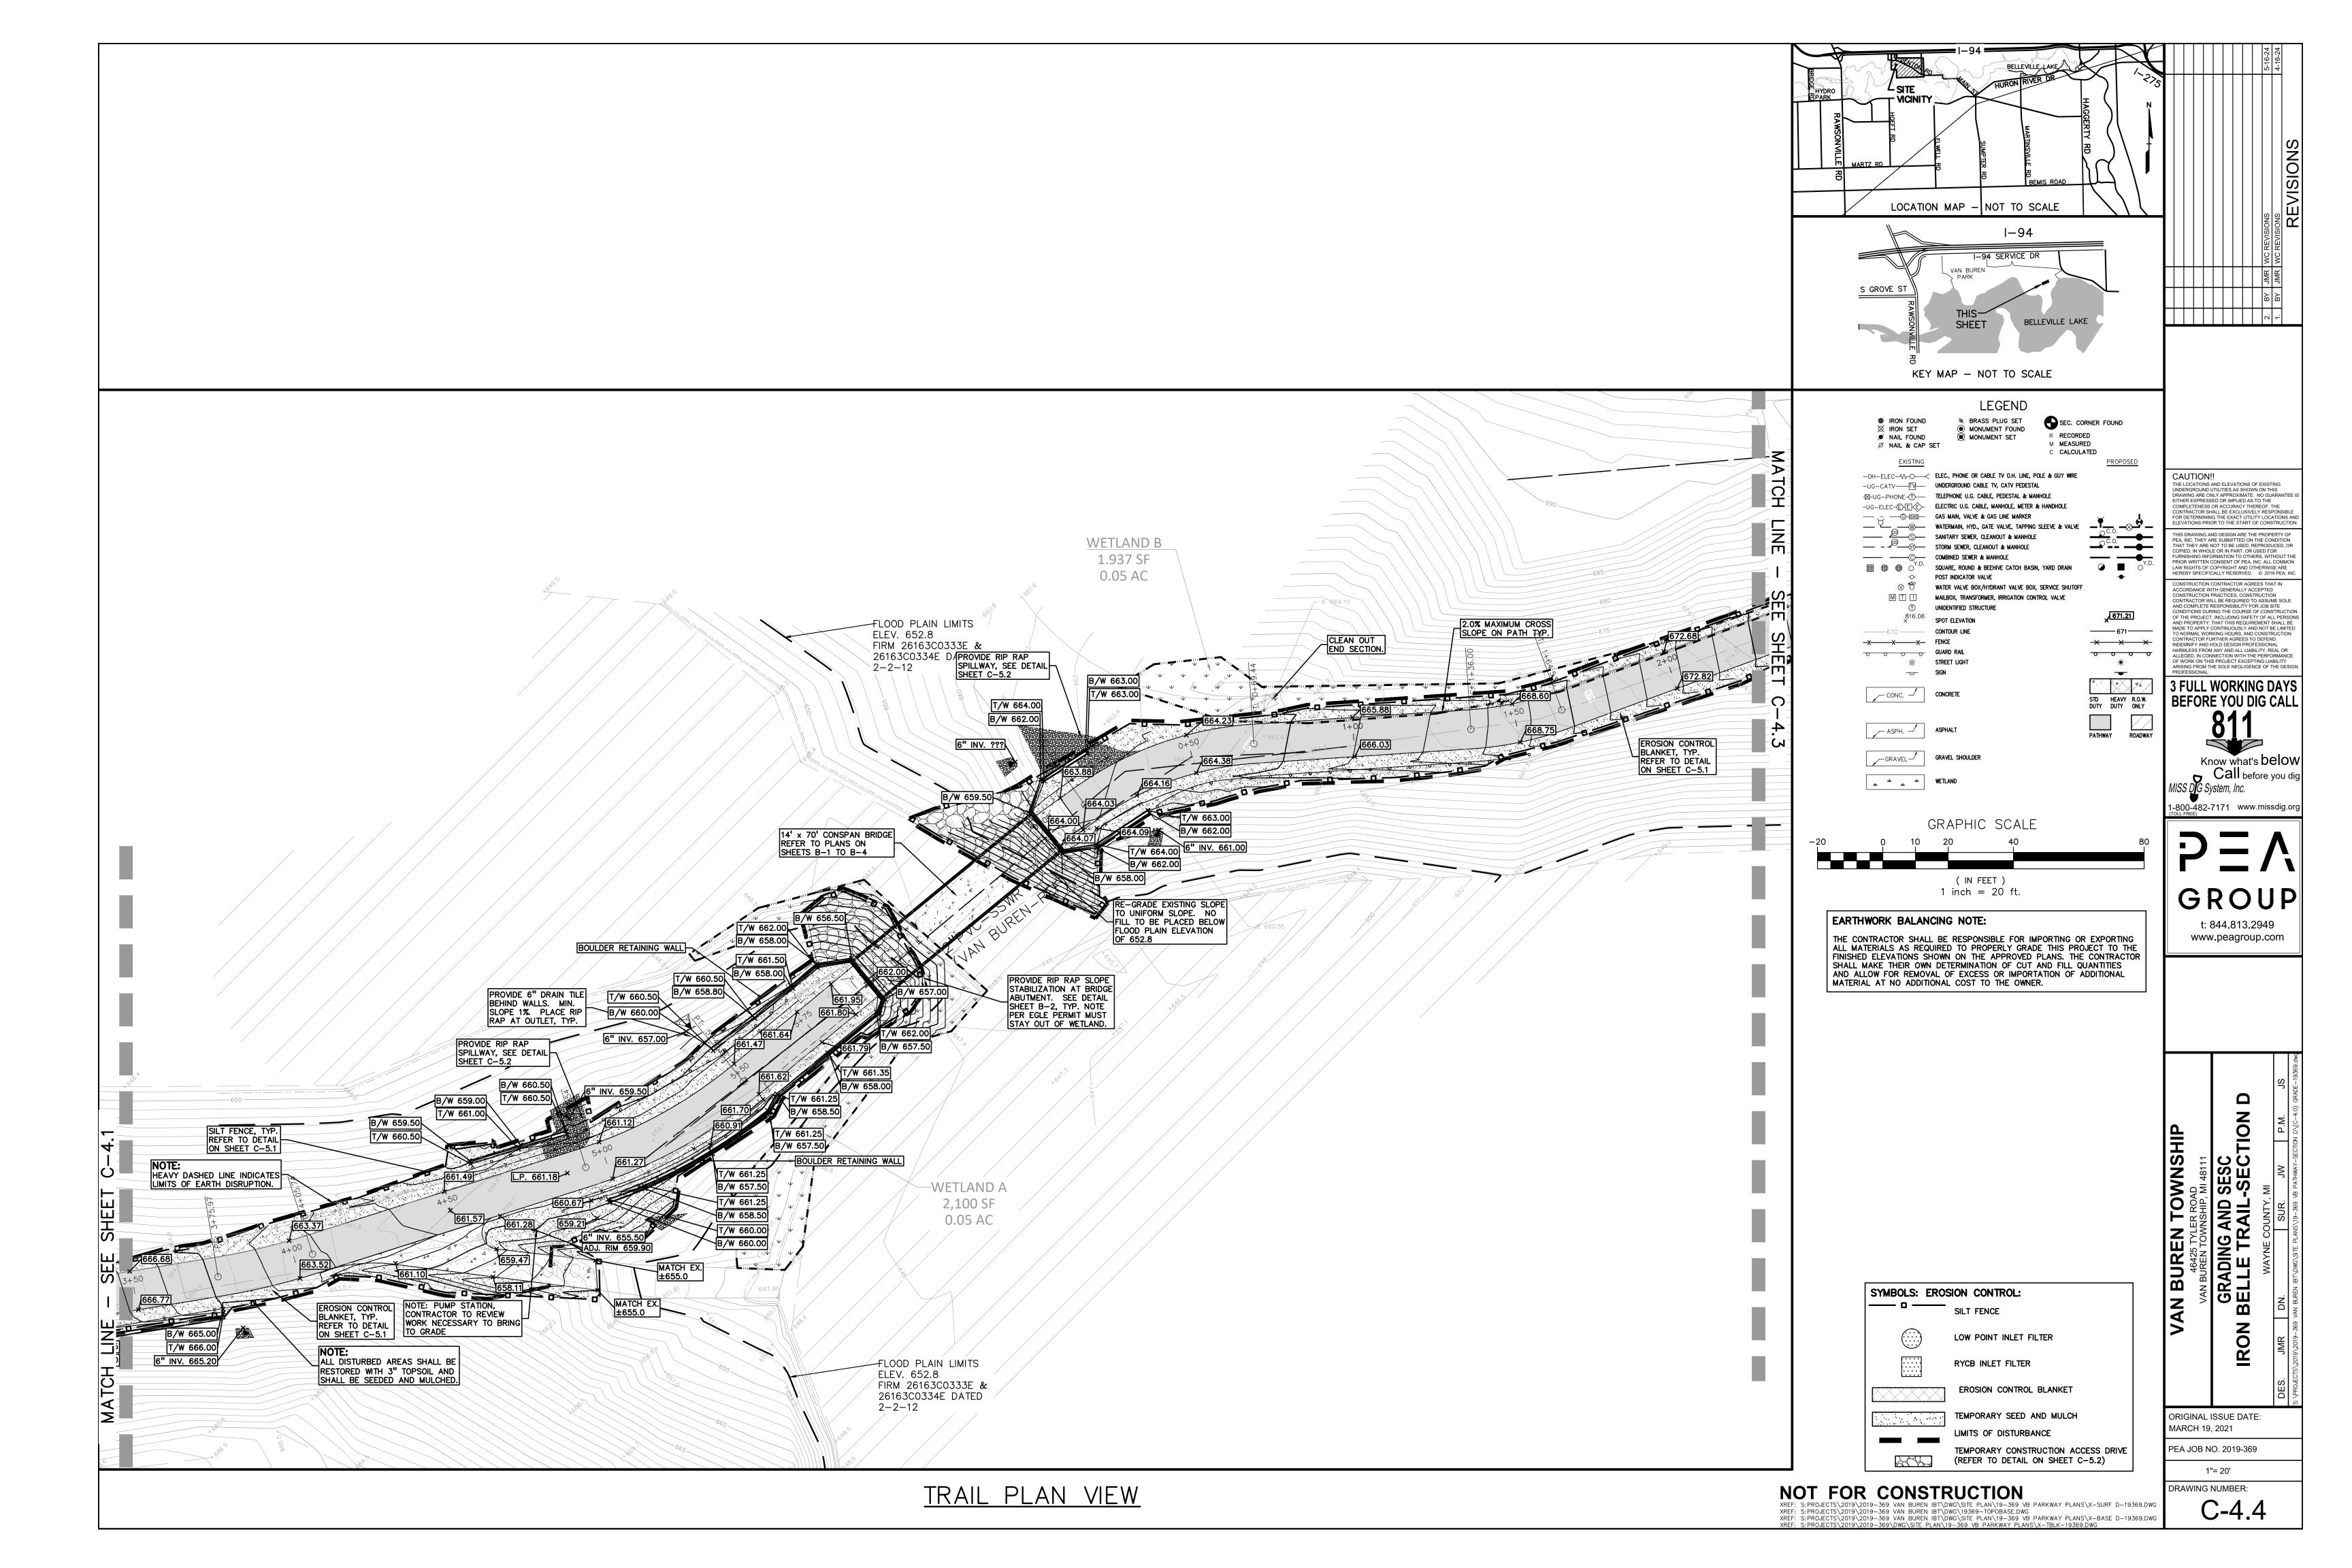
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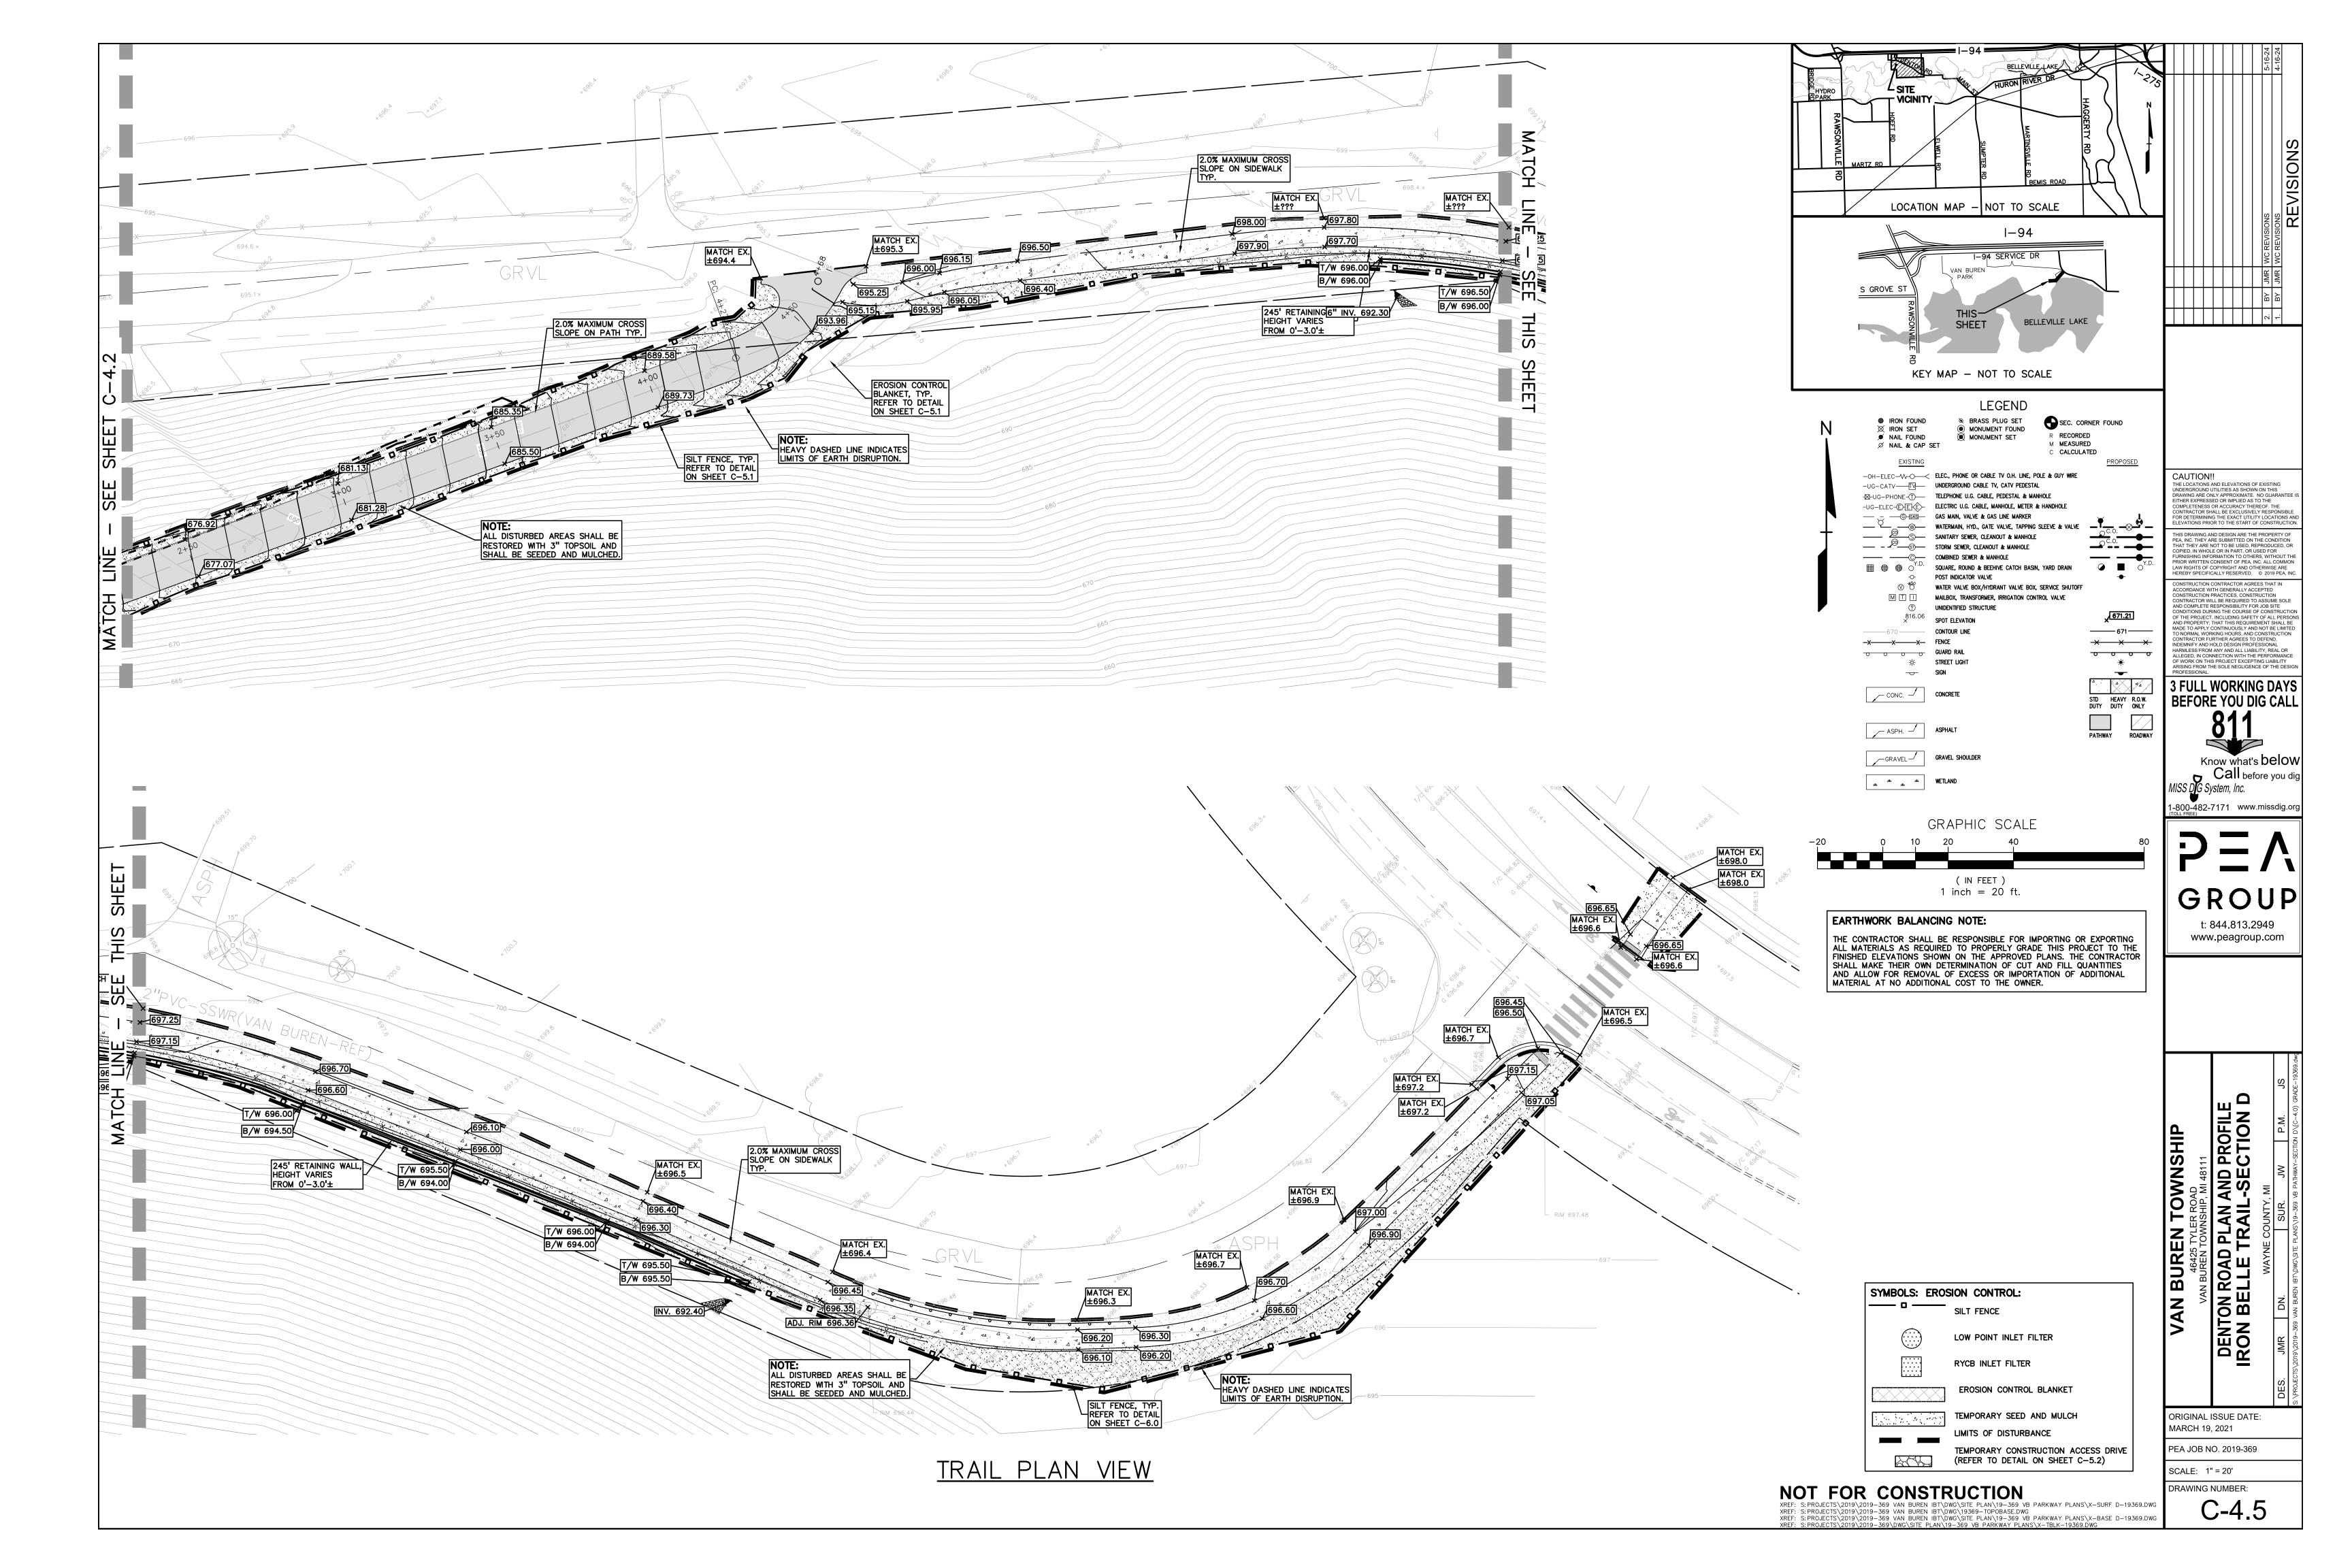
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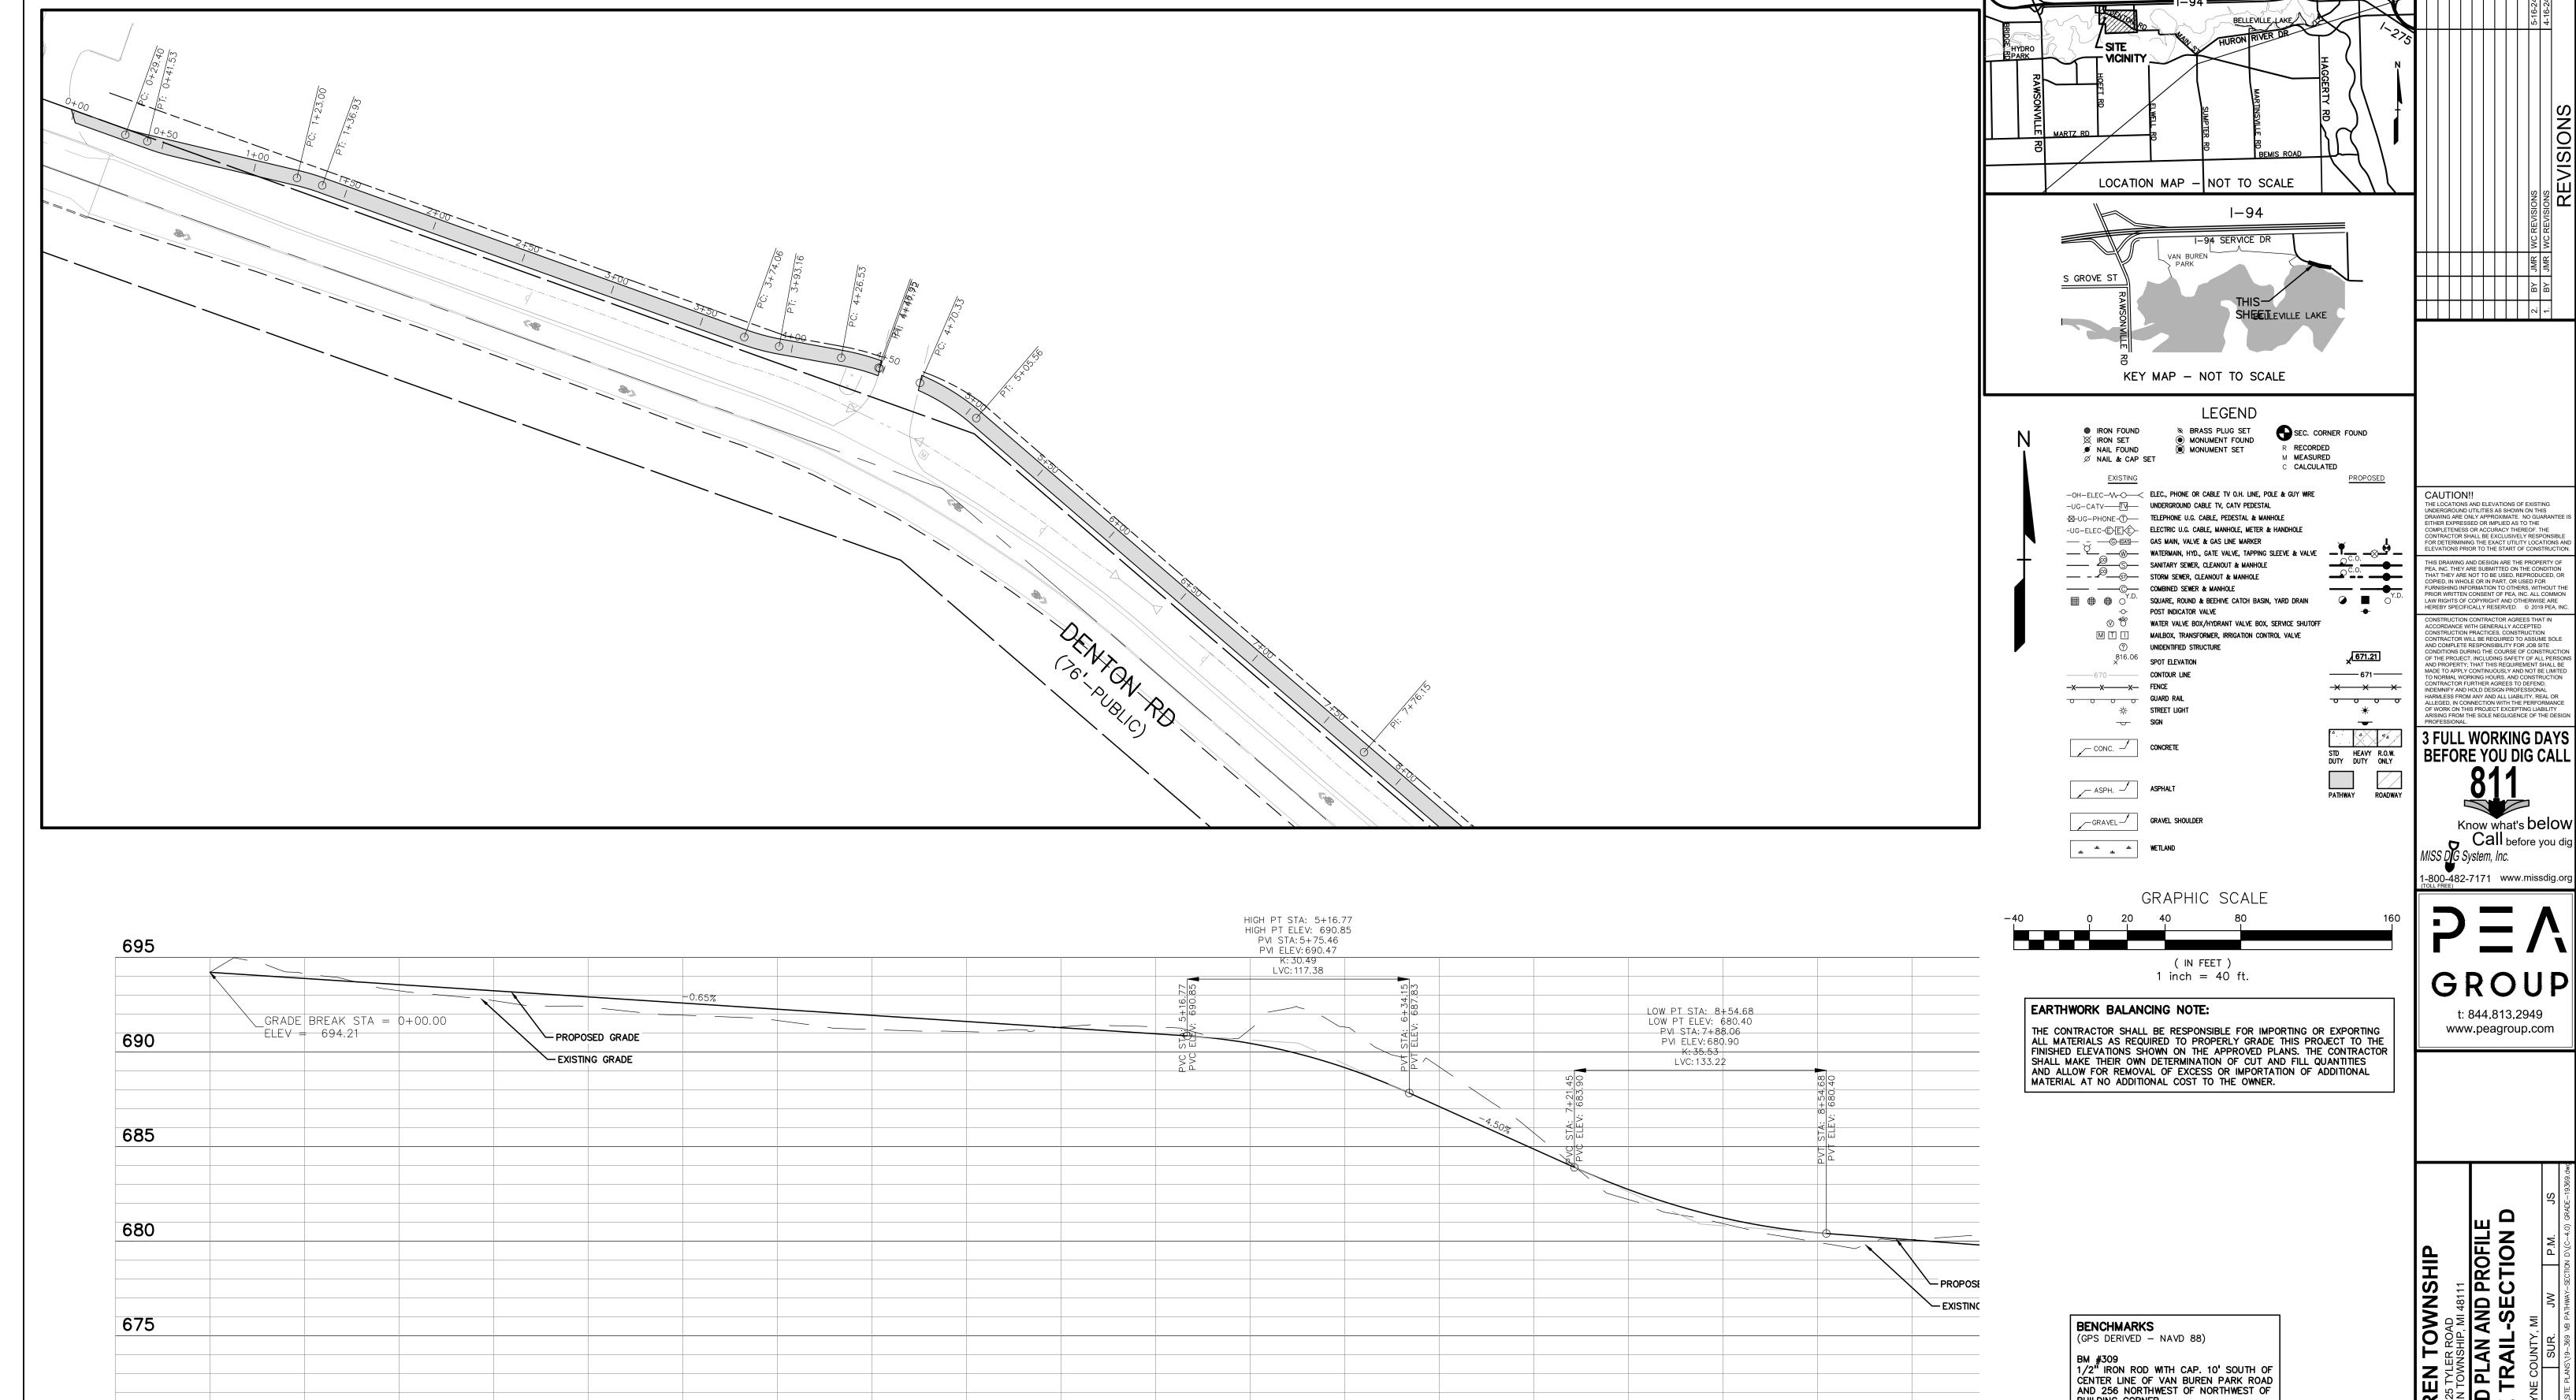
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692.4 **692.91**

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.2 .93

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5+00

3+00

DENTON ROAD PA

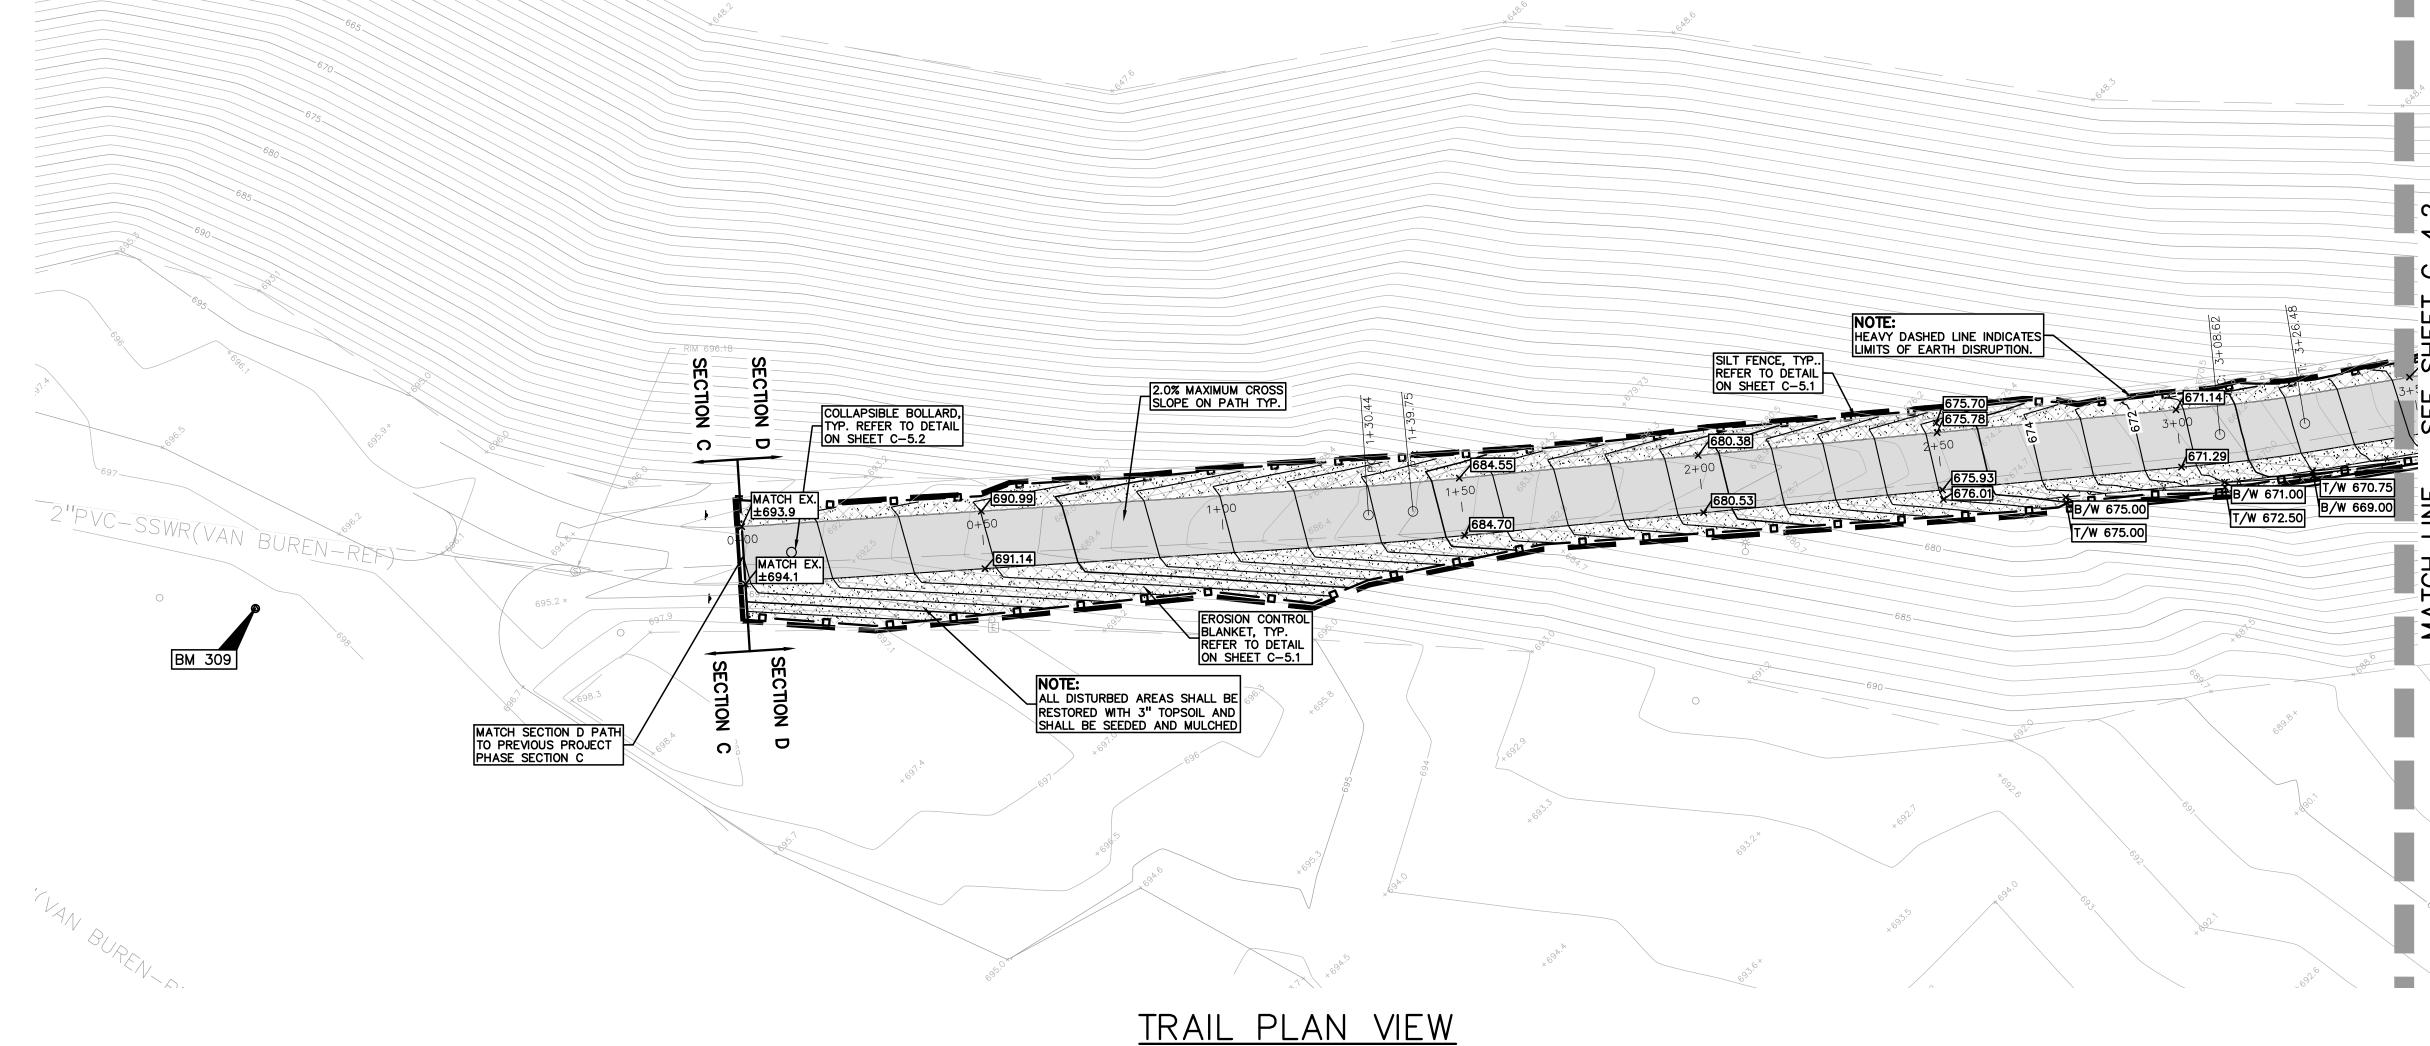9+00

682.2 **682.73**

8+00

7+00

689.2 **687.11**

6+00

BUILDING CORNER. ELEV.- 698.59

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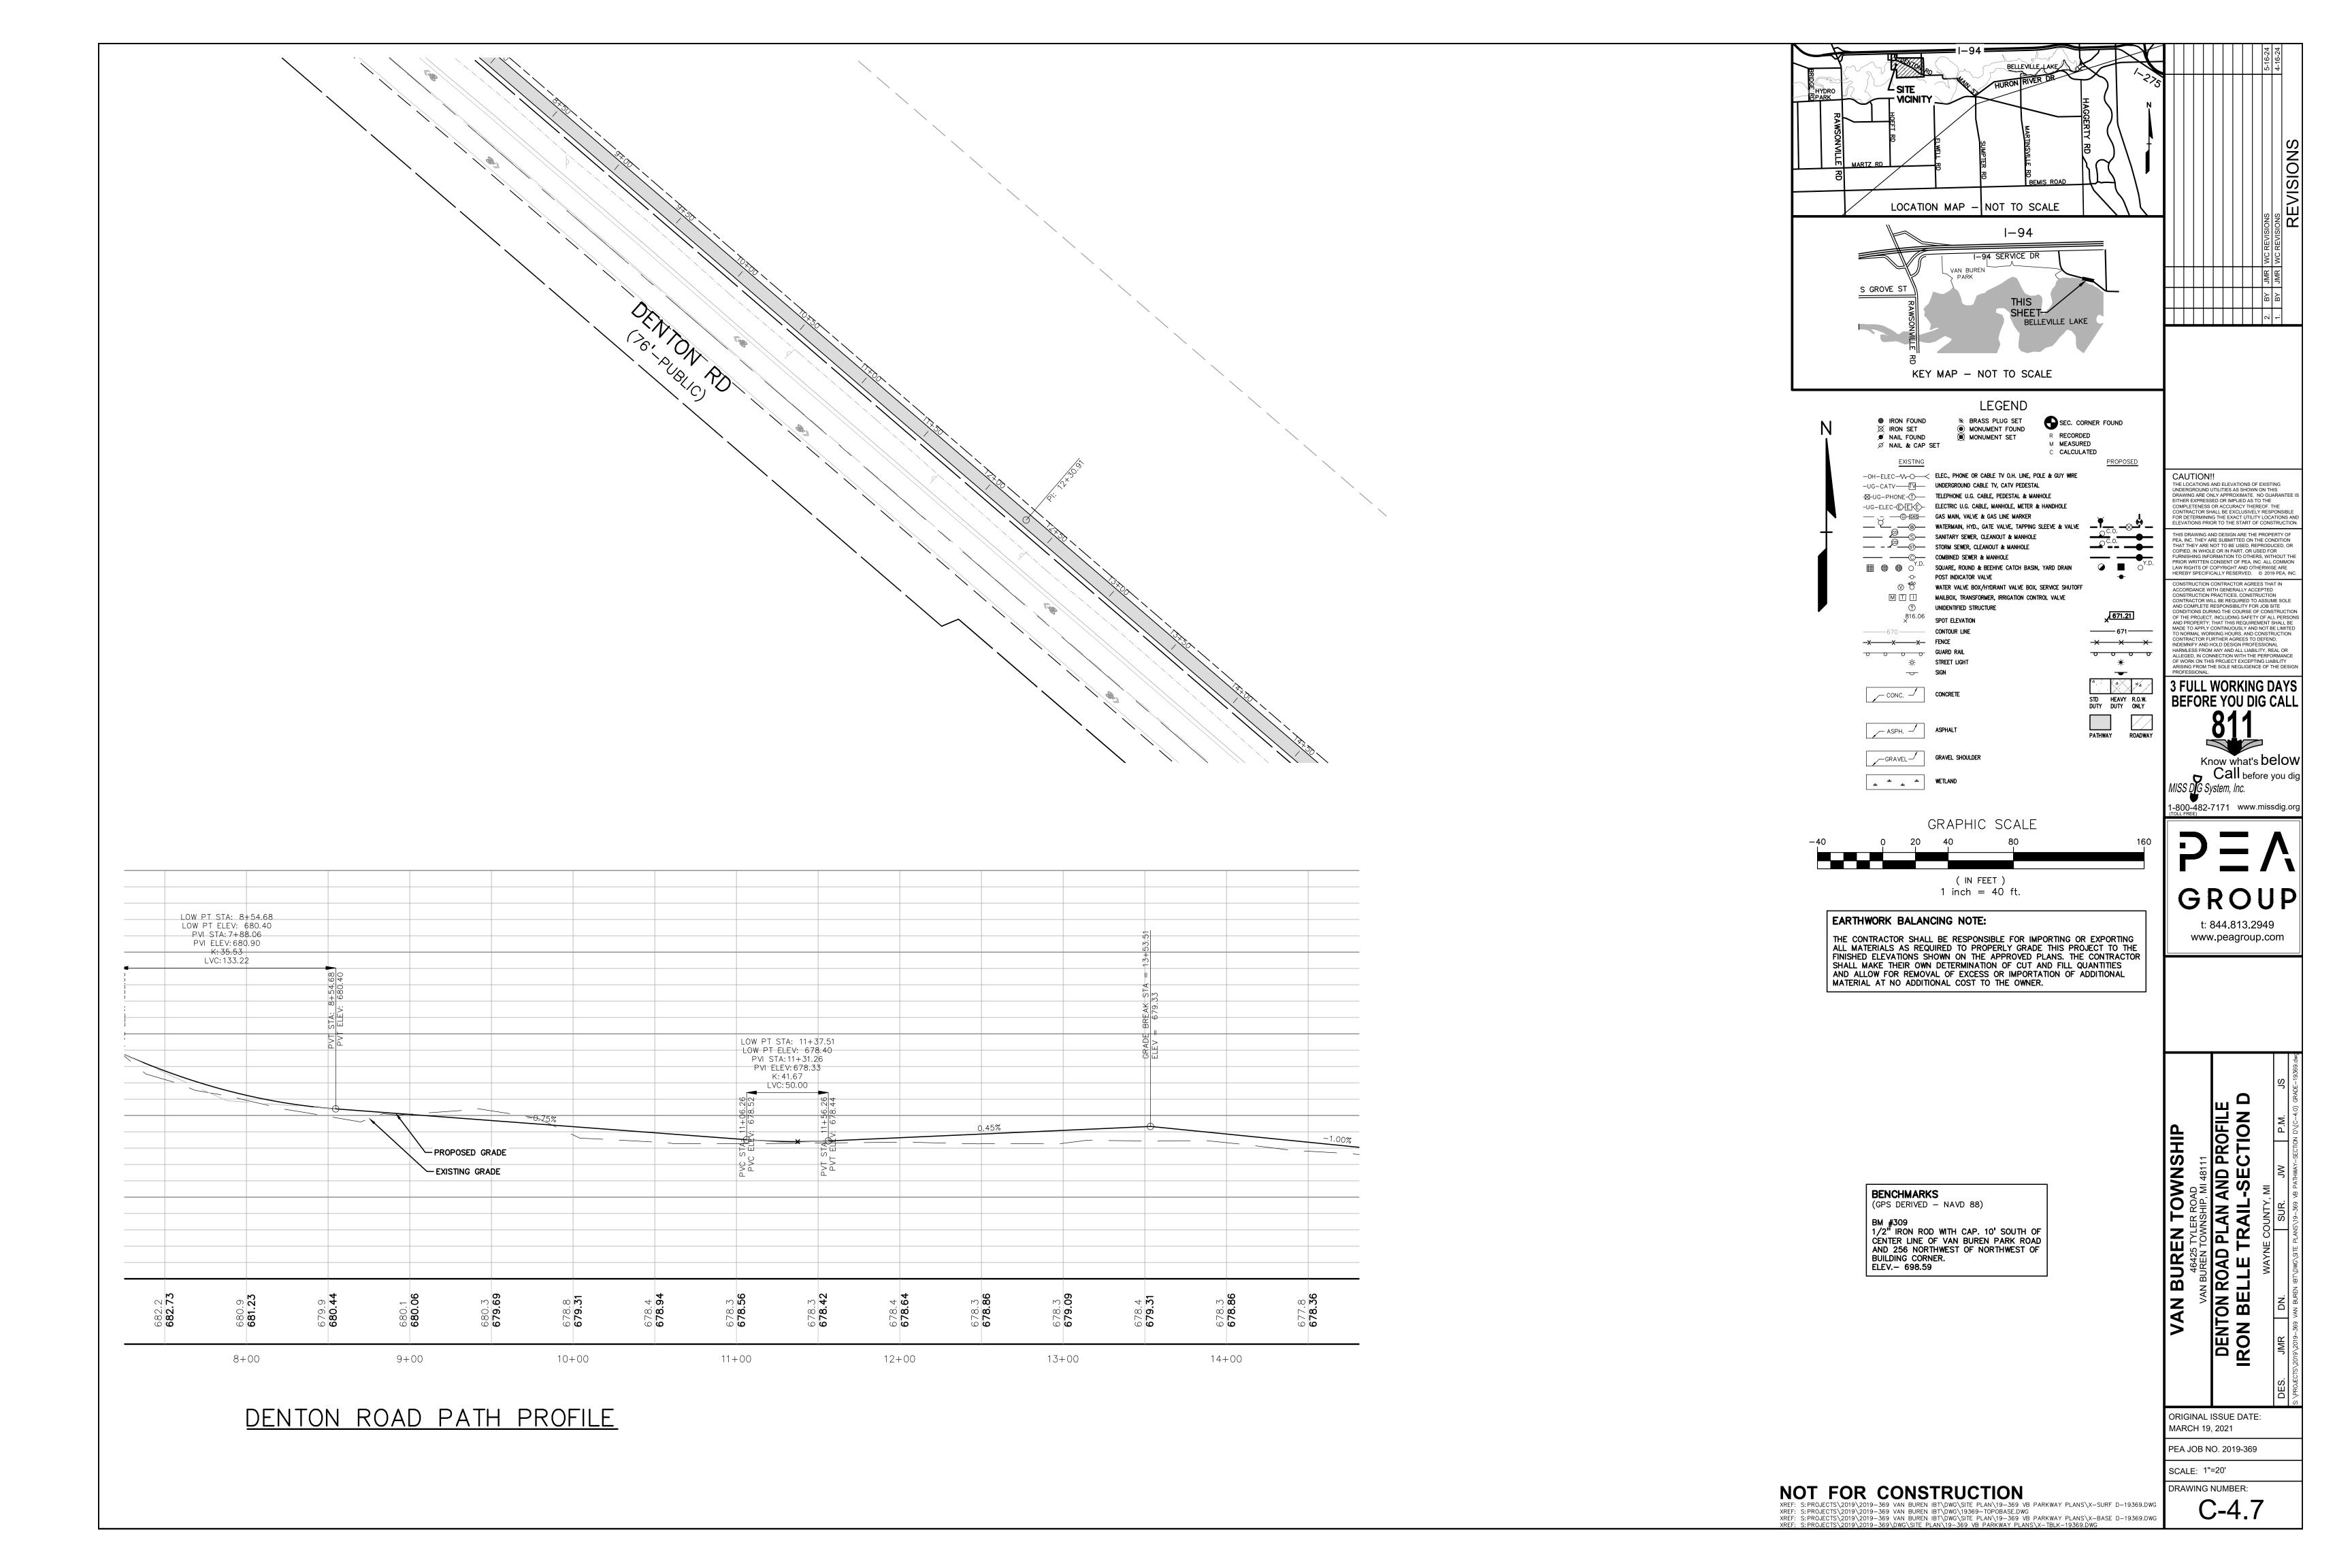
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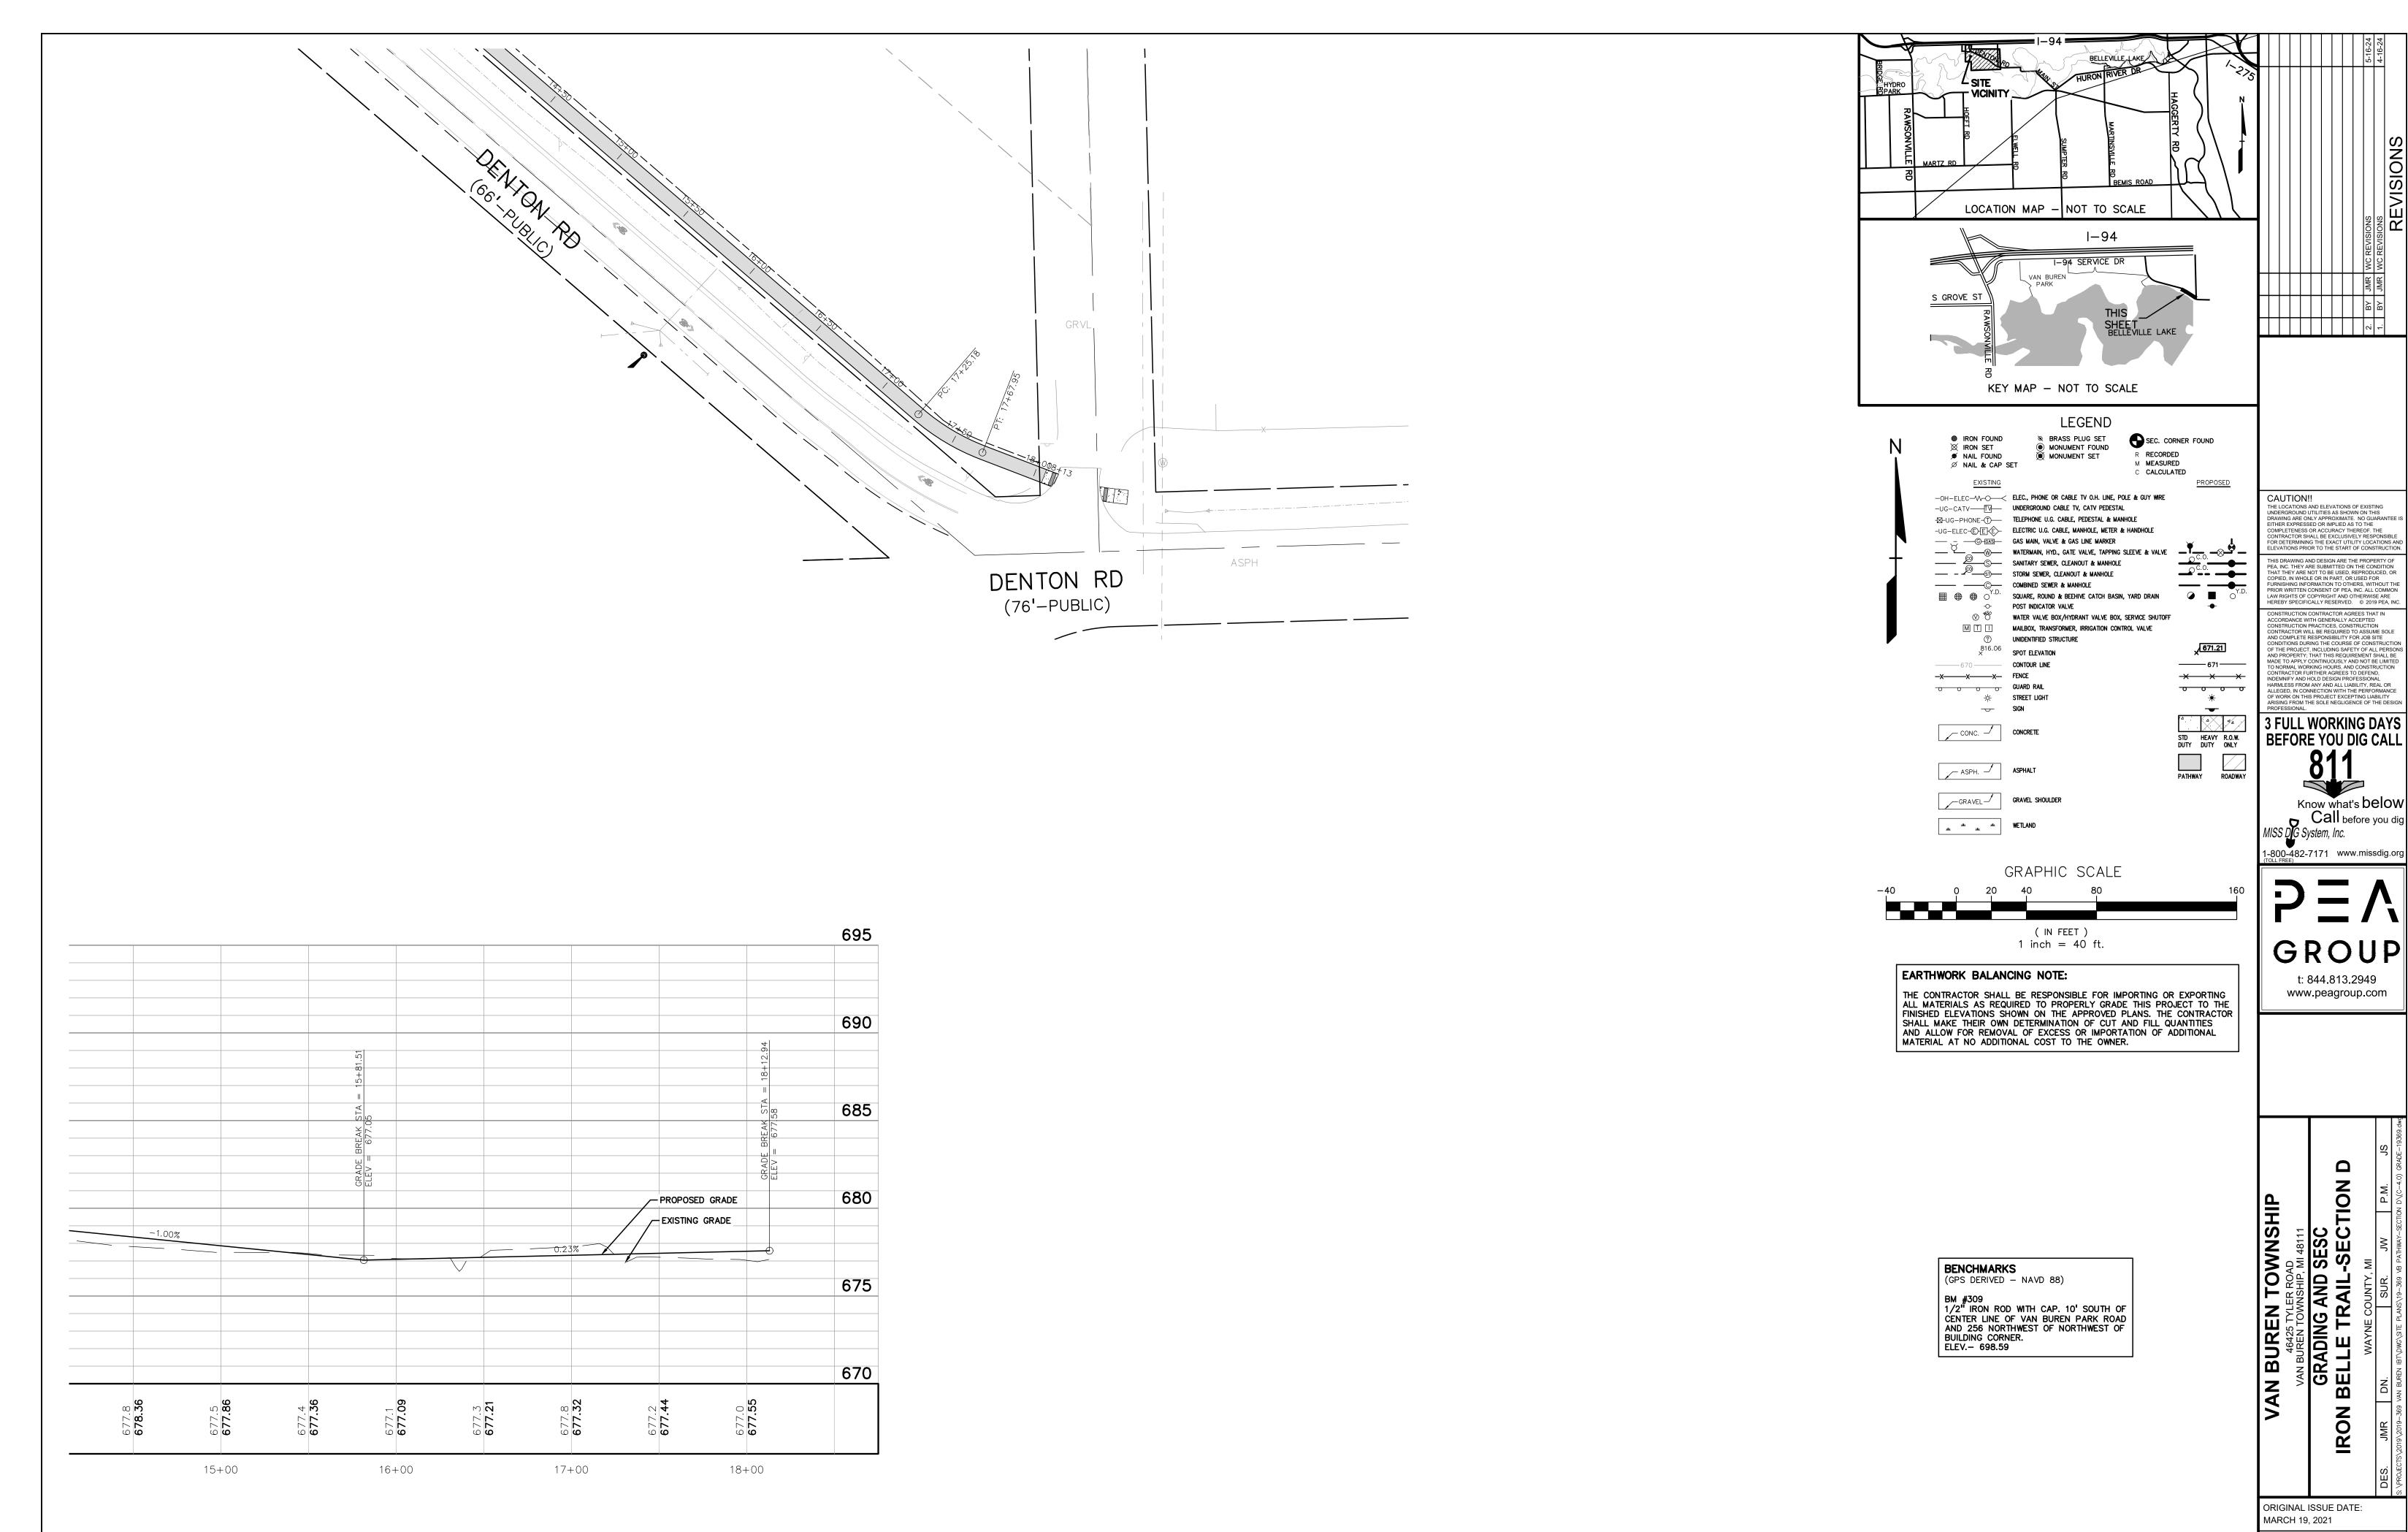
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ON ROAD PLAN AND PROFILE

BELLE TRAIL-SECTION D VAN BUREN TOWNSHIP
46425 TYLER ROAD DENT ORIGINAL ISSUE DATE: MARCH 19, 2021 PEA JOB NO. 2019-369 SCALE: 1"=20' DRAWING NUMBER: C-4.6

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XREF: S:PROJECTS\2019\2019-369 VAN BUREN IBT\DWG\19369-TOPOBASE.DWG

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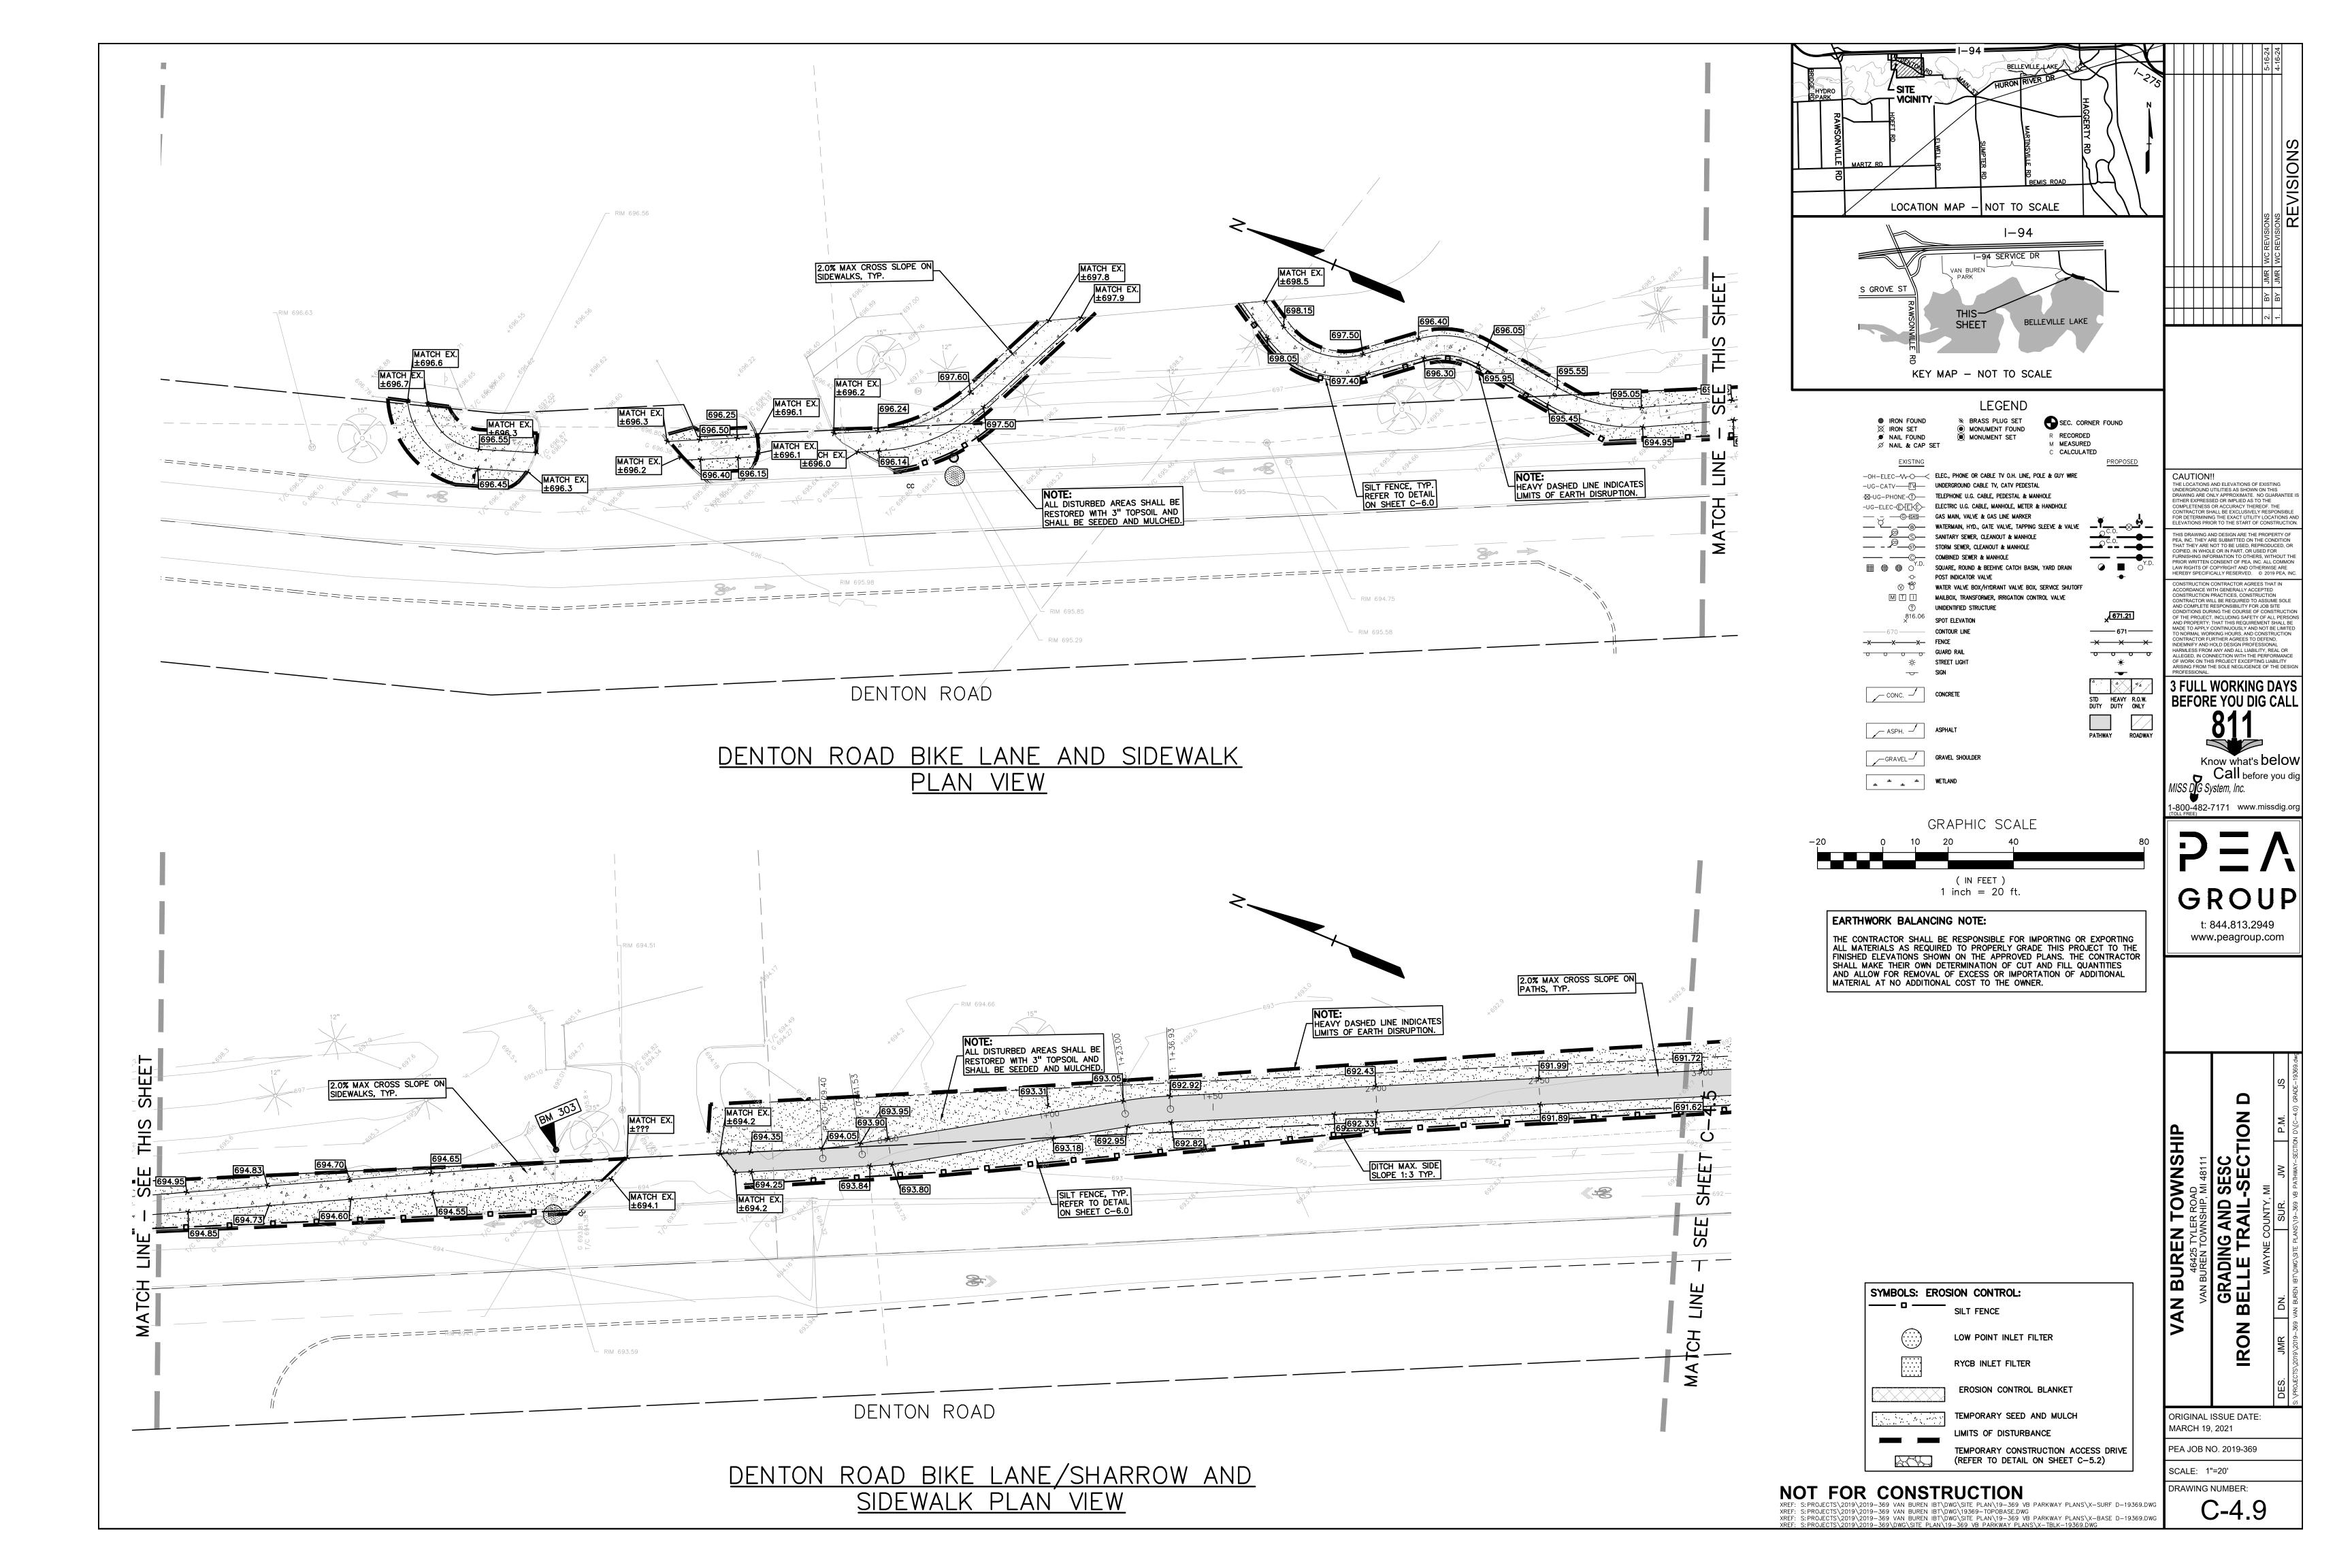
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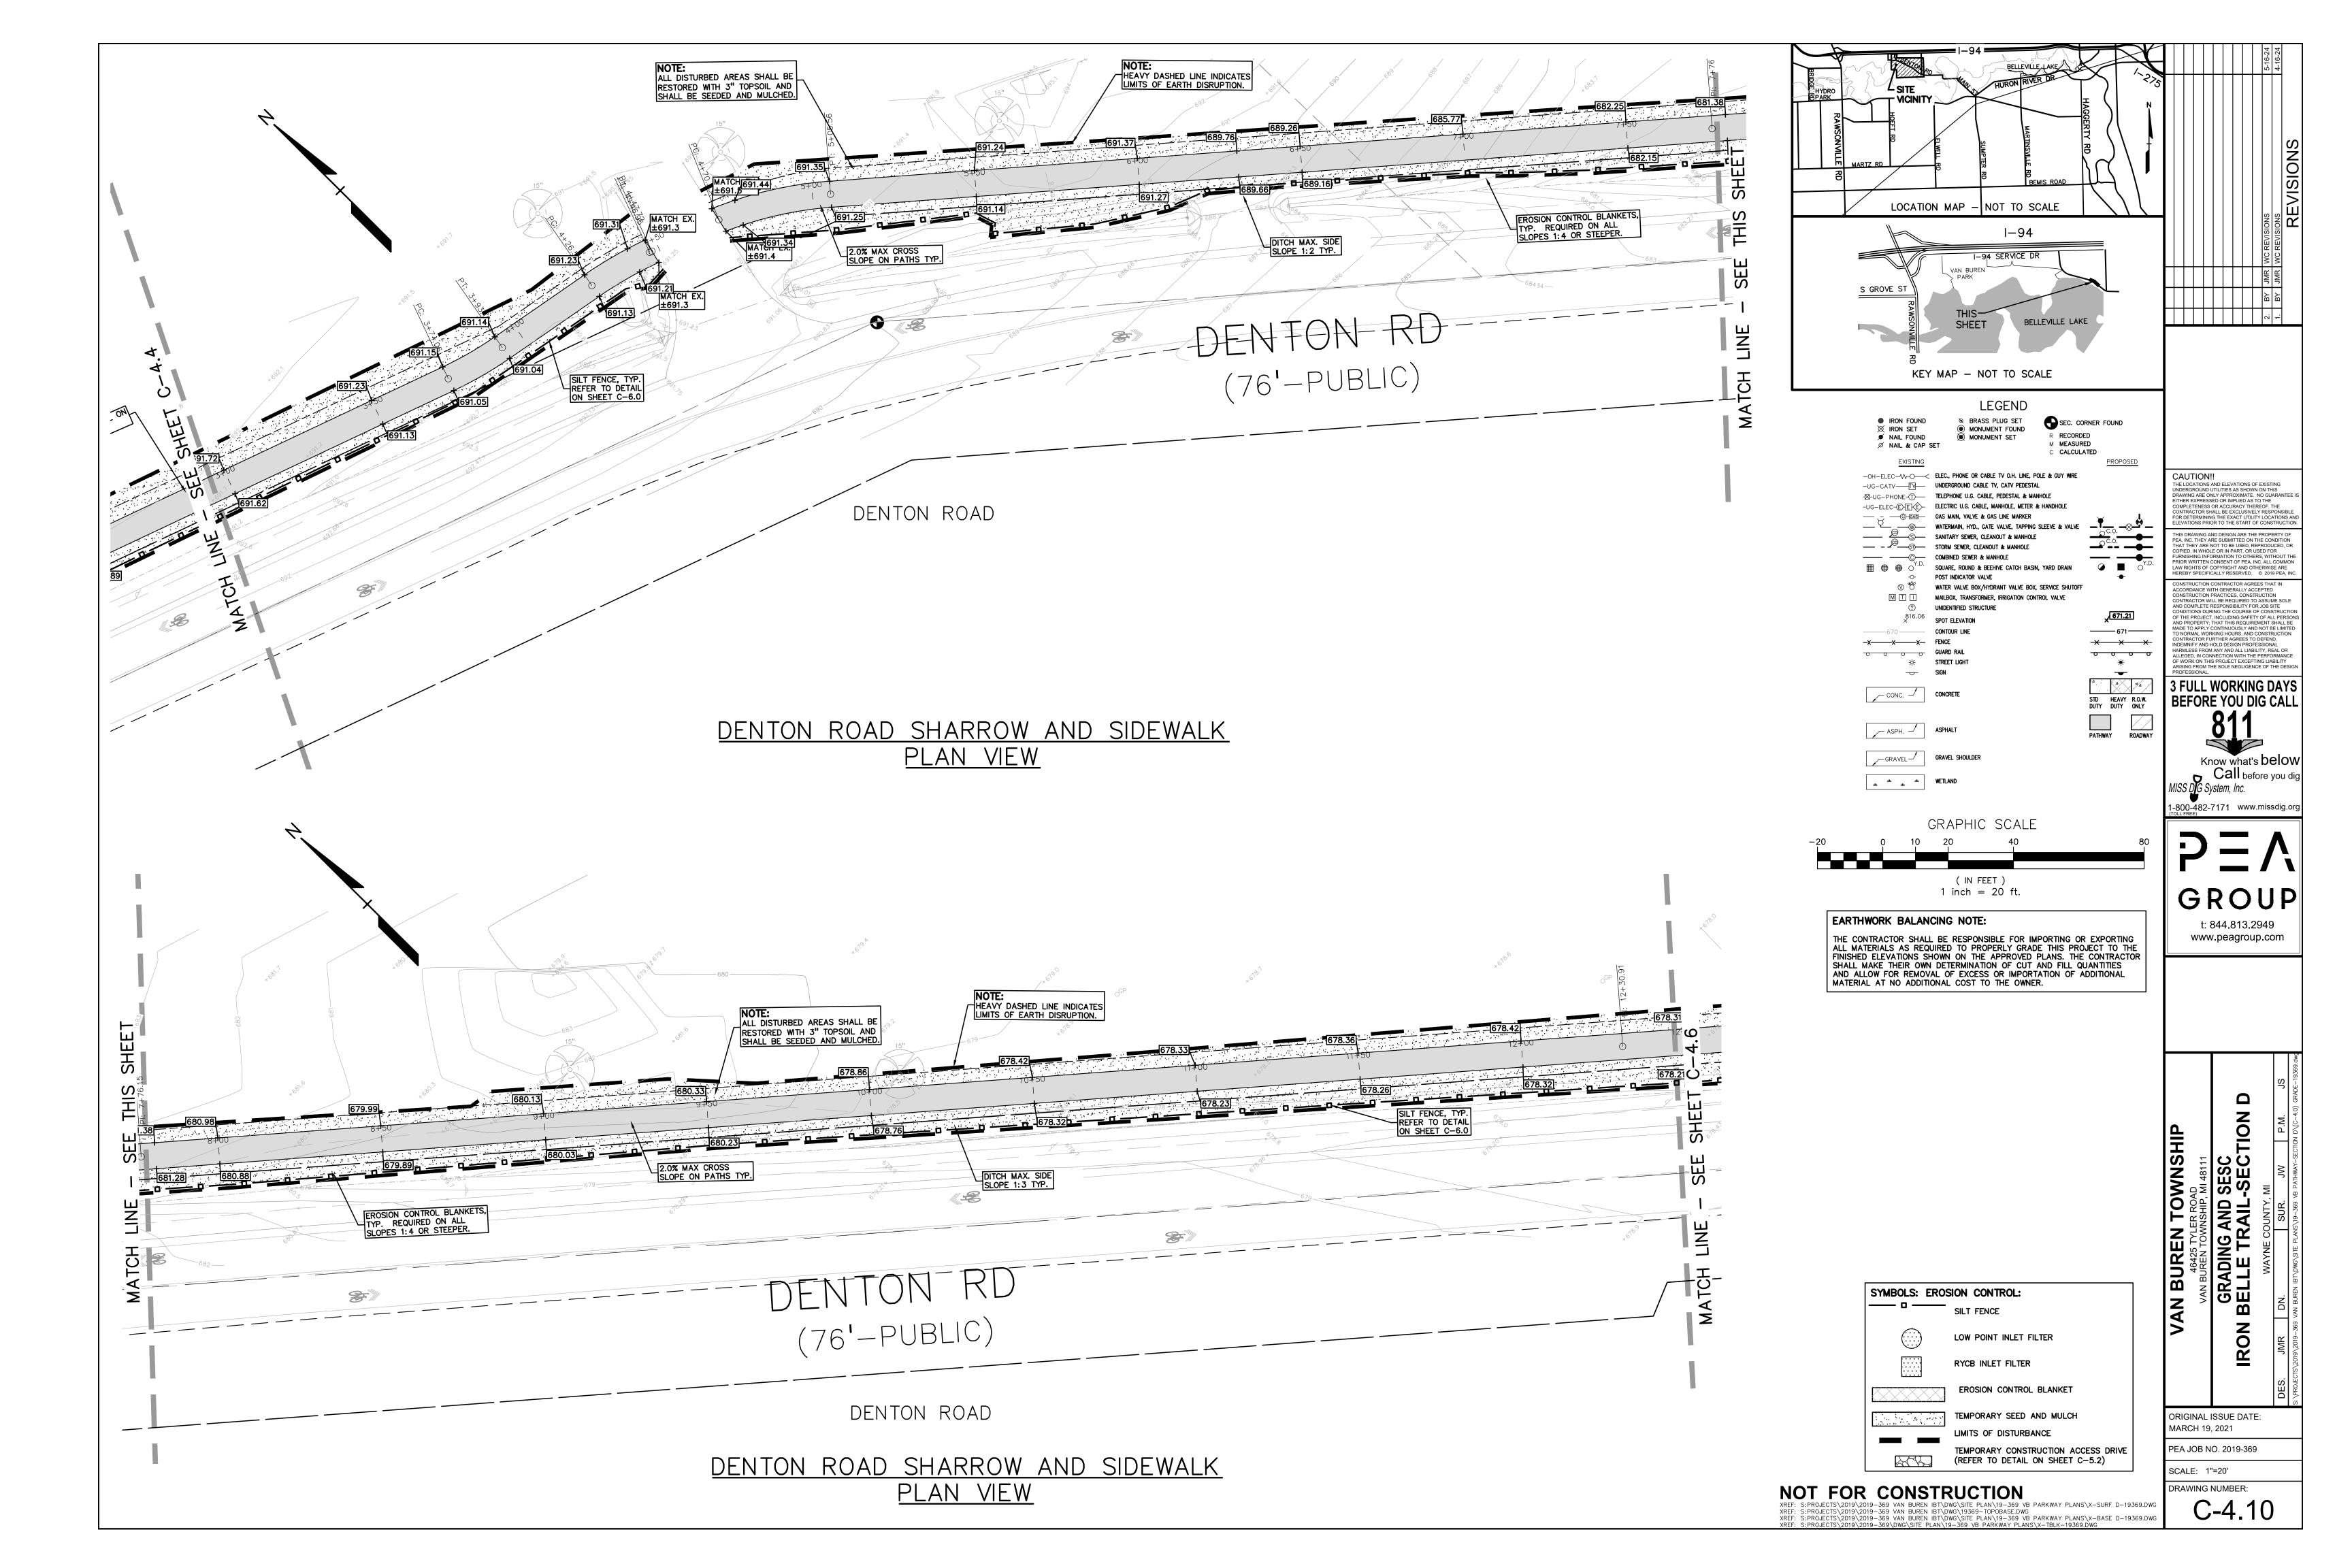
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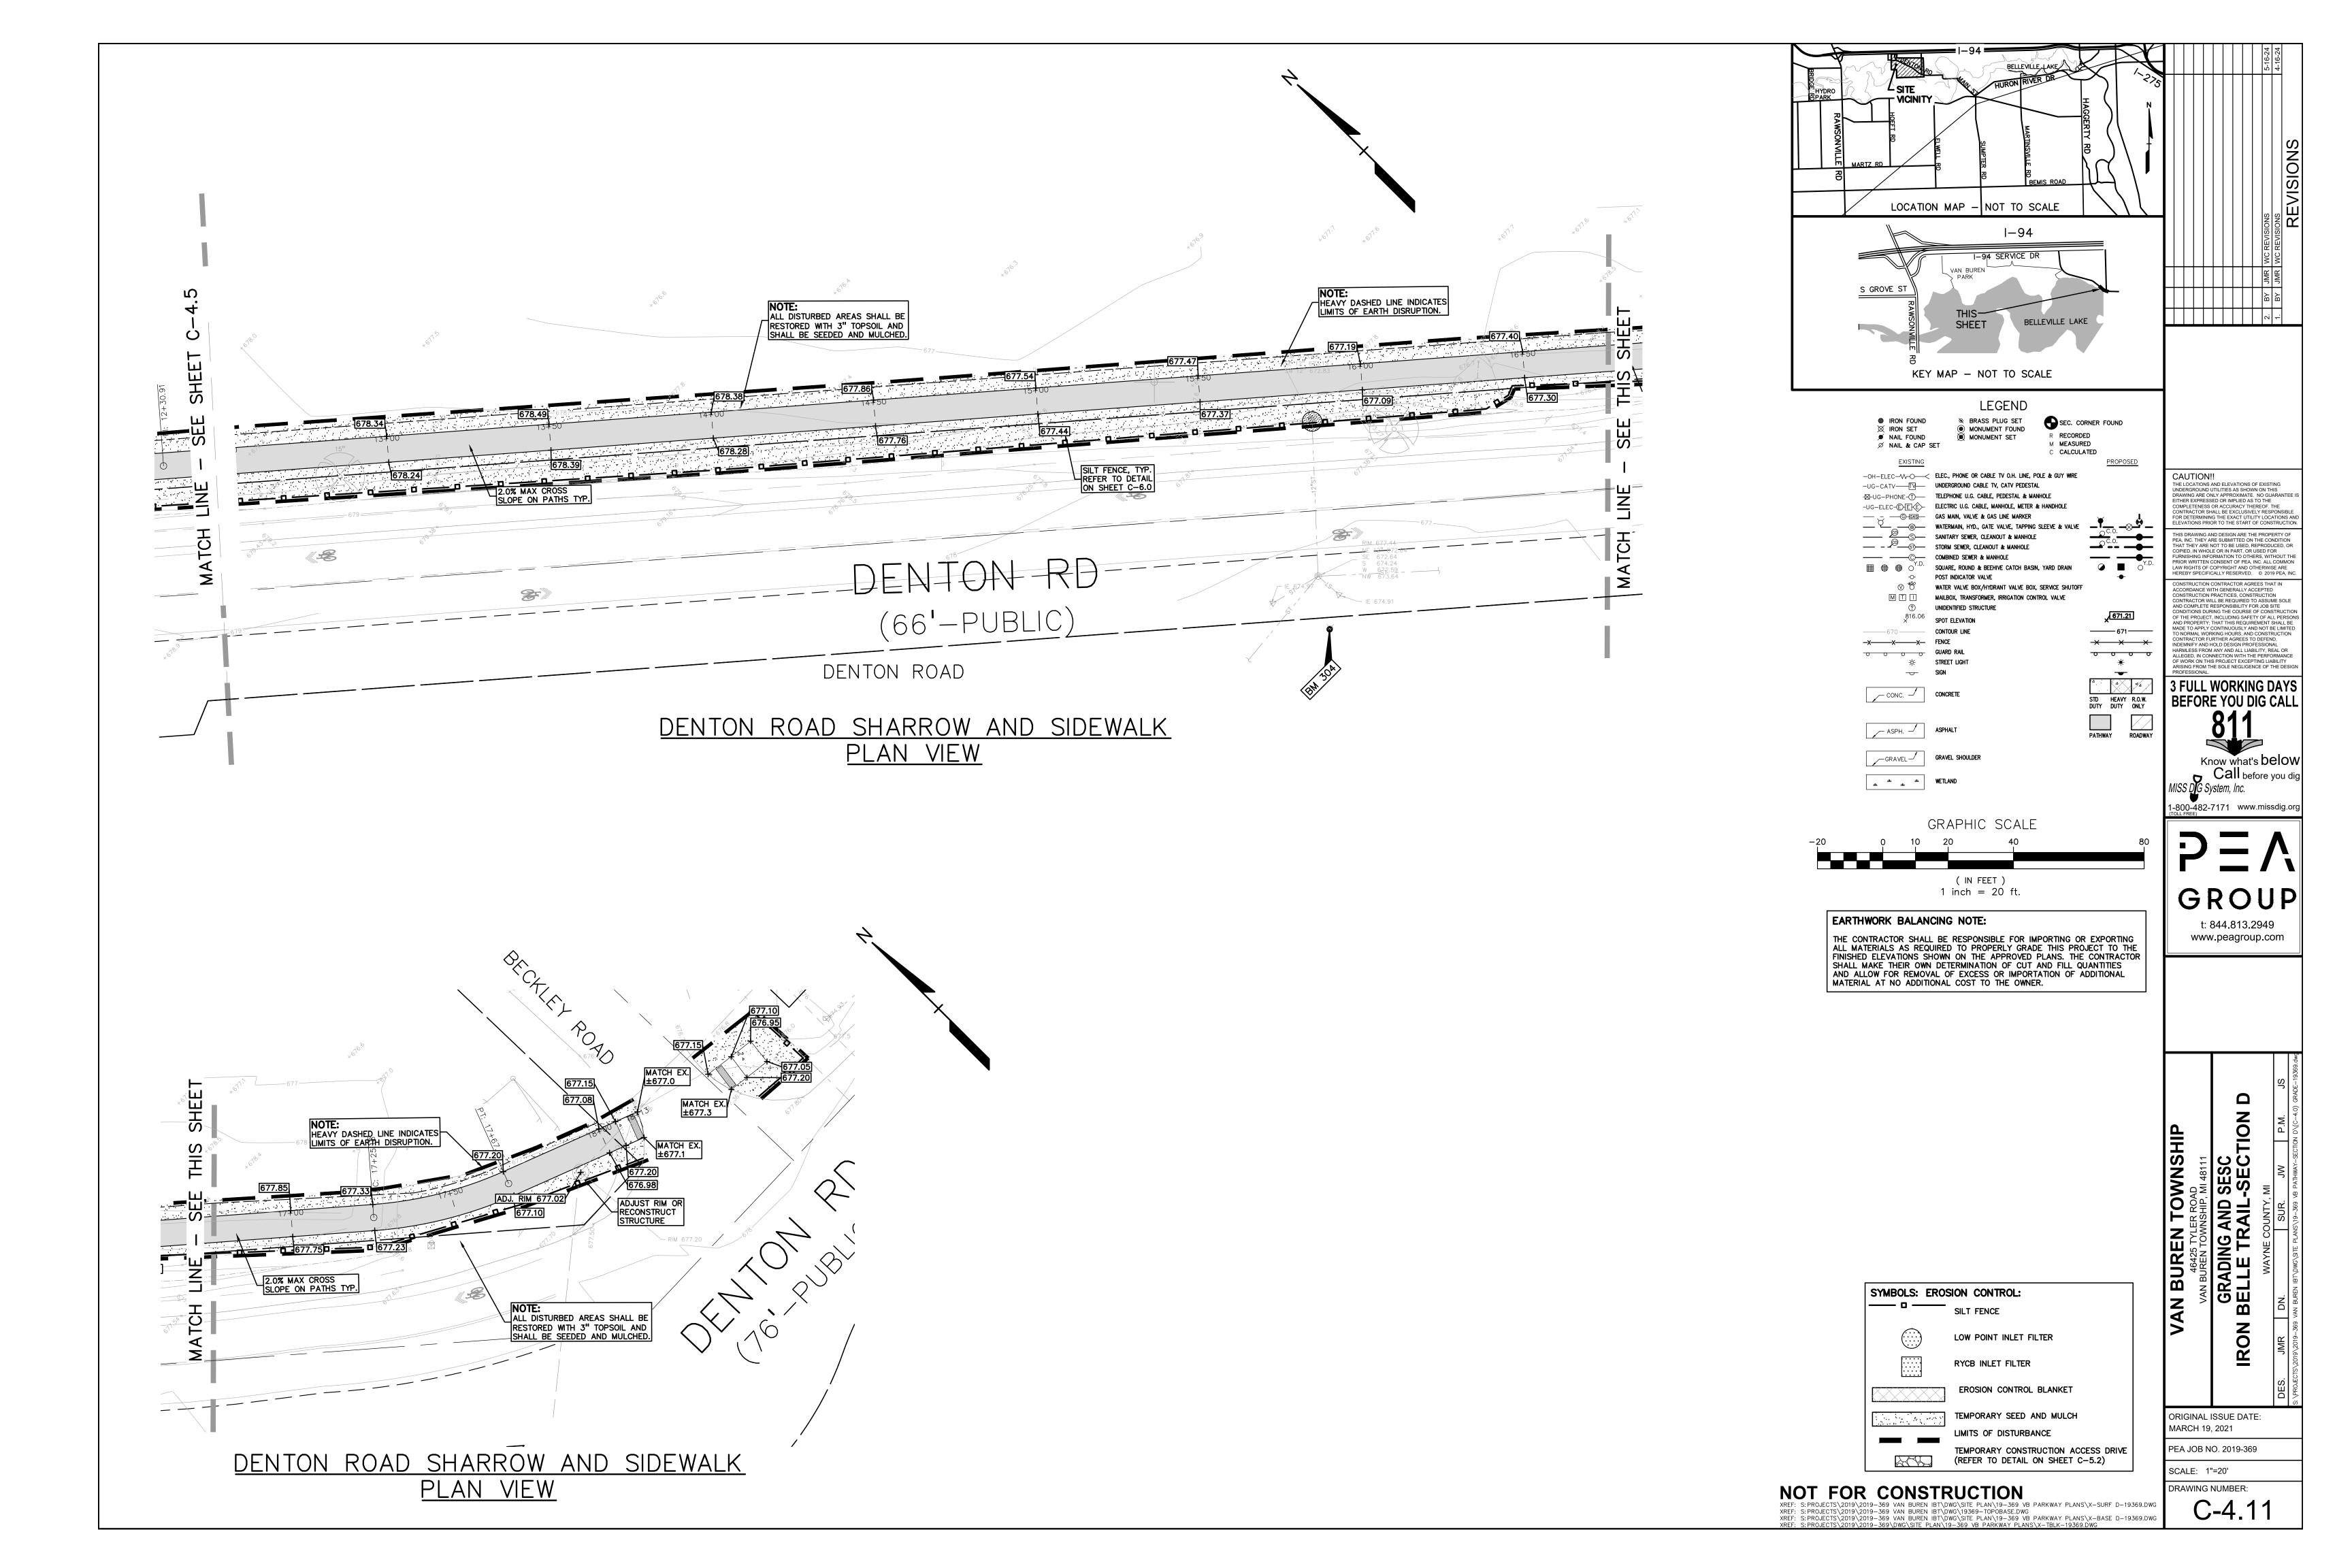
ORIGINAL ISSUE DATE: MARCH 19, 2021


PEA JOB NO. 2019-369 SCALE: 1"=20'


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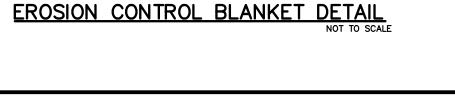









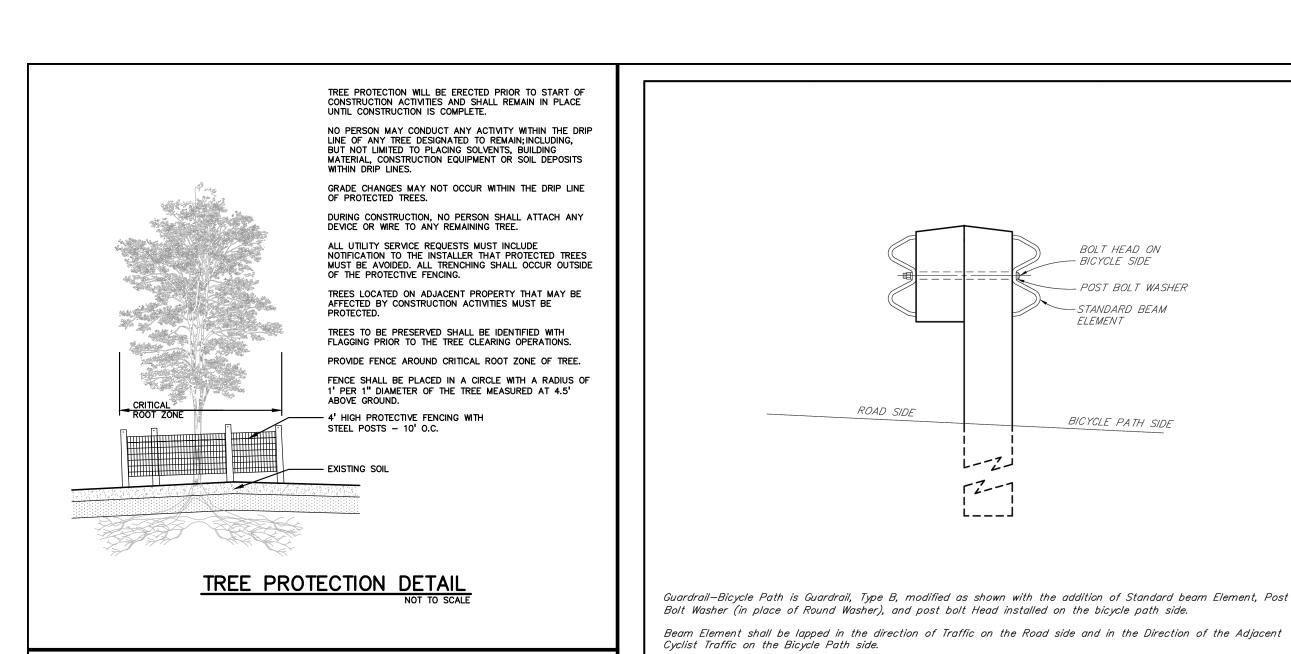

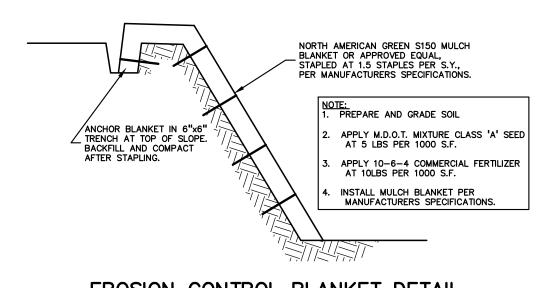

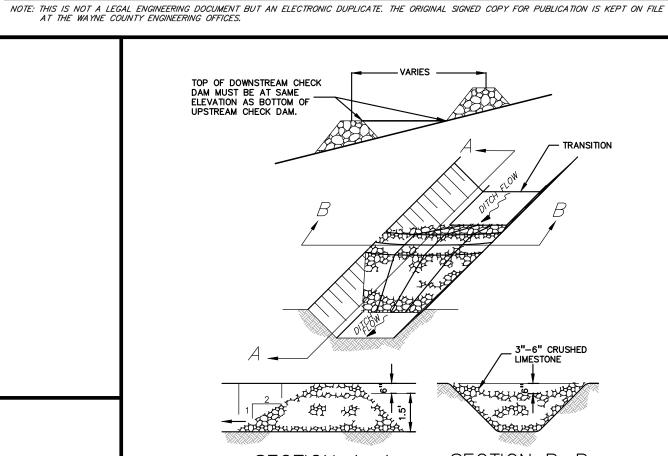

ROAD SIDE

For details not shown see M.D.O.T. Standard Plans R-60 Series.

REVISION DATE:

DIRECTOR OF ENGINEERING

TZ---

MDOT GUARDRAIL 'TYPE B MODIFIED' IS TO BE USED ON SOUTH SIDE OF ROAD - SEE SHEET C-3.0-3.1 FOR LOCATION

ALL GUARD RAIL IS TO HAVE MSKT TERMNAL ENDS - REFER TO MDOT STANDARD PLANS AND DETAILS


MDOT GUARDRAIL 'TYPE B' IS TO BE USED ON NORTH SIDE OF ROAD — SEE SHEET C-3.0-3.1 FOR LOCATION AND REFER TO MDOT STANDARD PLANS R-60 SERIES FOR DETAILS

WAYNE COUNTY DEPARTMENT OF PUBLIC SERVICES

ENGINEERING DIVISION/PERMIT OFFICE

PERMIT STANDARDS

GUARDRAIL-BICYCLE PATH

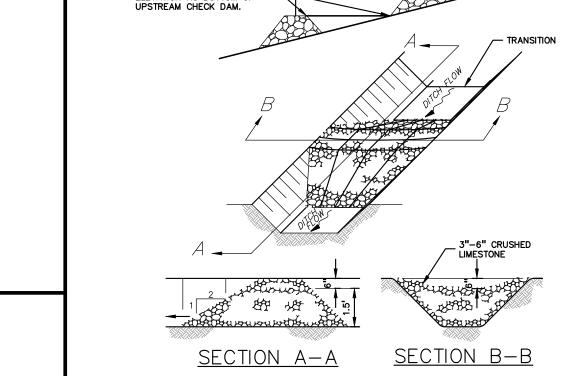

(TO BE USED IN DITCHES W/ SLOPE OF 2.5% OR MORE)

PERMANENT STONE CHECK DAM DETAIL

BOLT HEAD ON

POST BOLT WASHER


STANDARD BEAM ELEMENT


BICYCLE PATH SIDE

M-1


SHEET 1 OF 1

BICYCLE SIDE

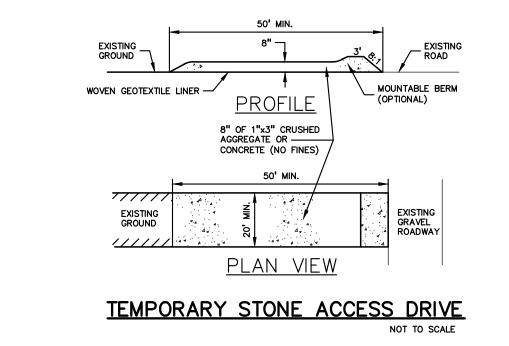


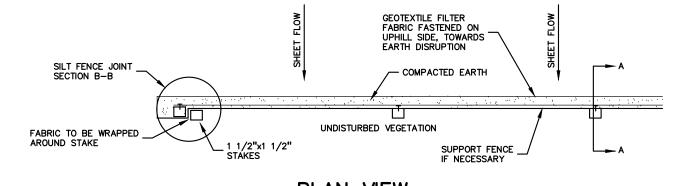


PLAN VIEW SPACING 6' MAX. 1/2" STAKES DRIVEN INTO GROUND 1', MIN. TWO WRAP MIN. -SALVAGED EDGES, TYP. GEOTEXTILE FILTER FABRIC (MIN. 10 GAL/MIN/SQ. FT) SUPPORT FENCE __/
IF NECESSARY 6" ANCHOR TRENCH FRONT VIEW

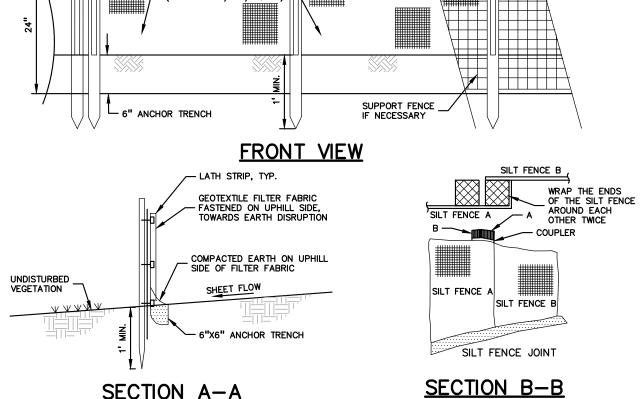



SECTION A-A SILT FENCE DETAIL

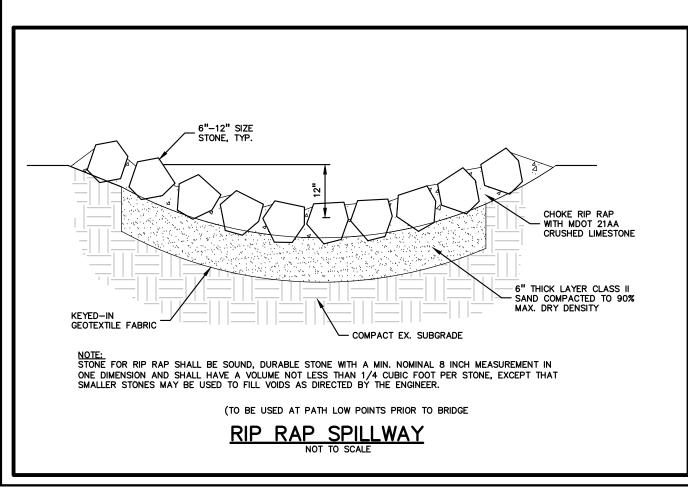


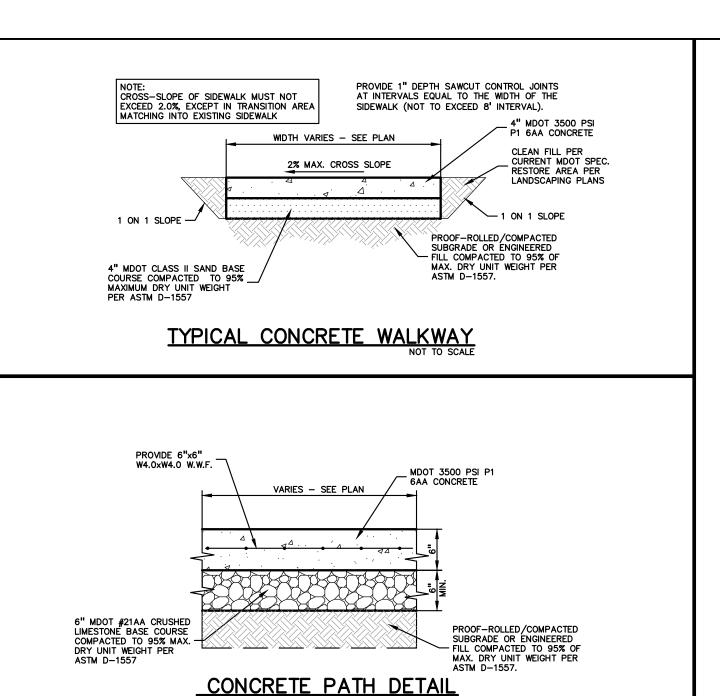



NOT TO SCALE

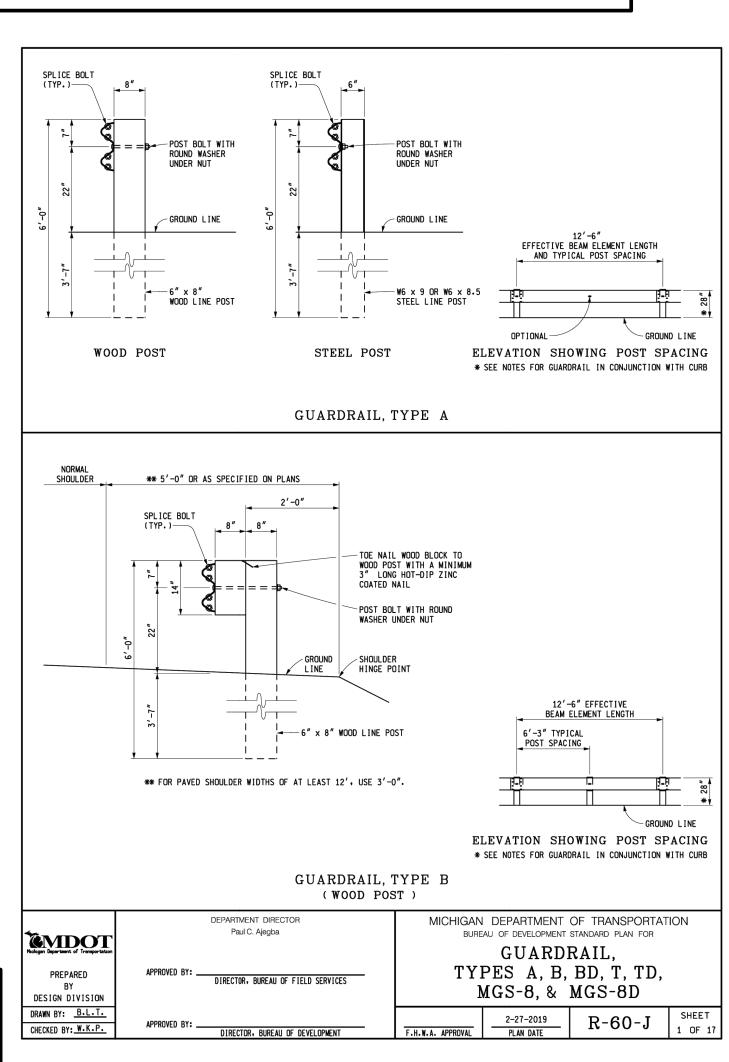


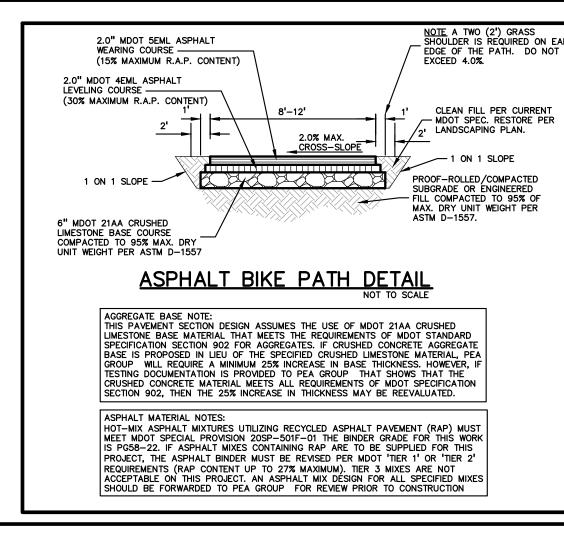

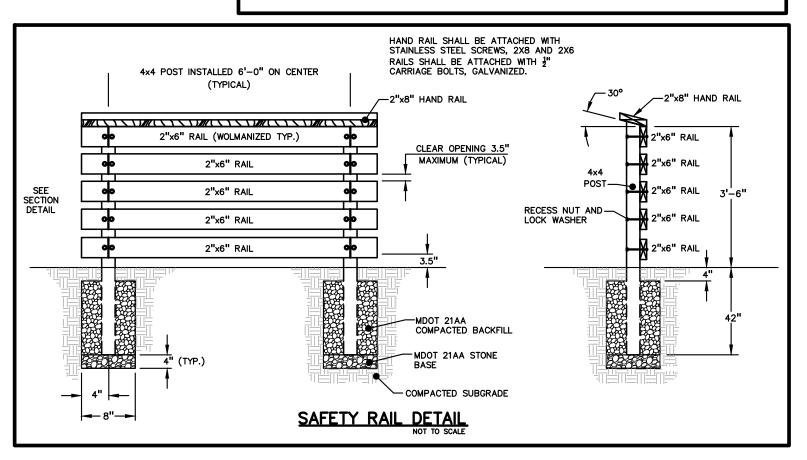

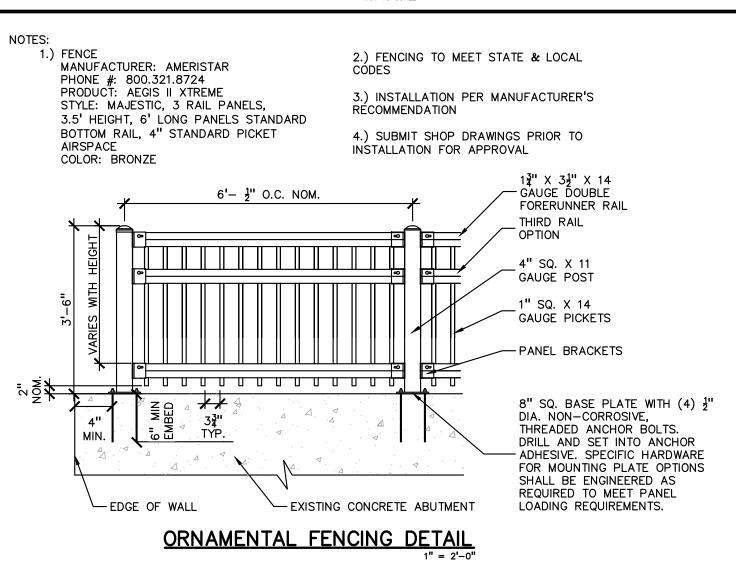

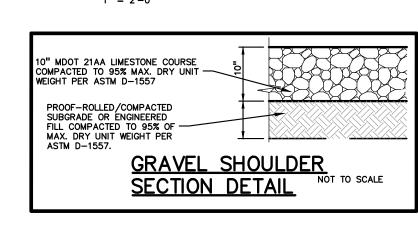

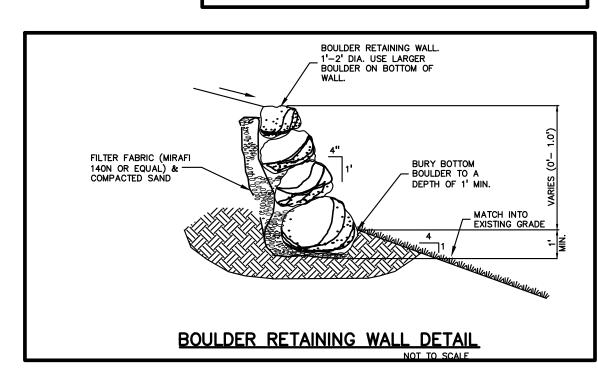

NOT FOR CONSTRUCTION XREF: S:PROJECTS\2019\2019-369 VAN BUREN IBT\DWG\SITE PLAN\19-369 VB PARKWAY PLANS\X-SURF D-19369.DWG XREF: S:PROJECTS\2019\2019-369 VAN BUREN IBT\DWG\19369-TOPOBASE.DWG XREF: S:PROJECTS\2019\2019-369 VAN BUREN IBT\0WG\SITE PLAN\19-369 VB PARKWAY PLANS\X-BASE D-19369.DWG XREF: S:PROJECTS\2019\2019-369\DWG\SITE PLAN\19-369 VB PARKWAY PLANS\X-TBLK-19369.DWG

CTION SNWO. AIL SHE TRAIL BUREN шΞ Z \Box RON ORIGINAL ISSUE DATE: MARCH 19, 2021

PEA JOB NO. 2019-369

DRAWING NUMBER:

C-5.

CAUTION!!

THE LOCATIONS AND ELEVATIONS OF EXISTING UNDERGROUND UTILITIES AS SHOWN ON THIS DRAWING ARE ONLY APPROXIMATE. NO GUARANTE EITHER EXPRESSED OR IMPLIED AS TO THE COMPLETENESS OR ACCURACY THEREOF. THE CONTRACTOR SHALL BE EXCLUSIVELY RESPONSIB FOR DETERMINING THE EXACT UTILITY LOCATIONS ELEVATIONS PRIOR TO THE START OF CONSTRUCT

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CONSTRUCTION CONTRACTOR AGREES THAT IN

CONSTRUCTION CONTRACTOR AGREES THAT IN ACCORDANCE WITH GENERALLY ACCEPTED CONSTRUCTION PRACTICES, CONSTRUCTION CONTRACTOR WILL BE REQUIRED TO ASSUME SOLE AND COMPLETE RESPONSIBILITY FOR JOB SITE CONDITIONS DURING THE COURSE OF CONSTRUCTION

OF THE PROJECT, INCLUDING SAFETY OF ALL PERSONAND PROPERTY; THAT THIS REQUIREMENT SHALL BI AND PROPERTY; THAT I HIS REQUIREMENT SHALL E MADE TO APPLY CONTINUOUSLY AND NOT BE LITT TO NORMAL WORKING HOURS, AND CONSTRUCTIOI CONTRACTOR FURTHER AGREES TO DEFEND, INDEMNIFY AND HOLD DESIGN PROFESSIONAL

INDEMINIT AND POLD DESIGNATION PROPERSIONAL
HARMLESS FROM ANY AND ALL LIABILITY, REAL OR
ALLEGED, IN CONNECTION WITH THE PERFORMANC
OF WORK ON THIS PROJECT EXCEPTING LIABILITY
ARISING FROM THE SOLE NEGLIGENCE OF THE DESI
PROCESSIONAL

3 FULL WORKING DAYS

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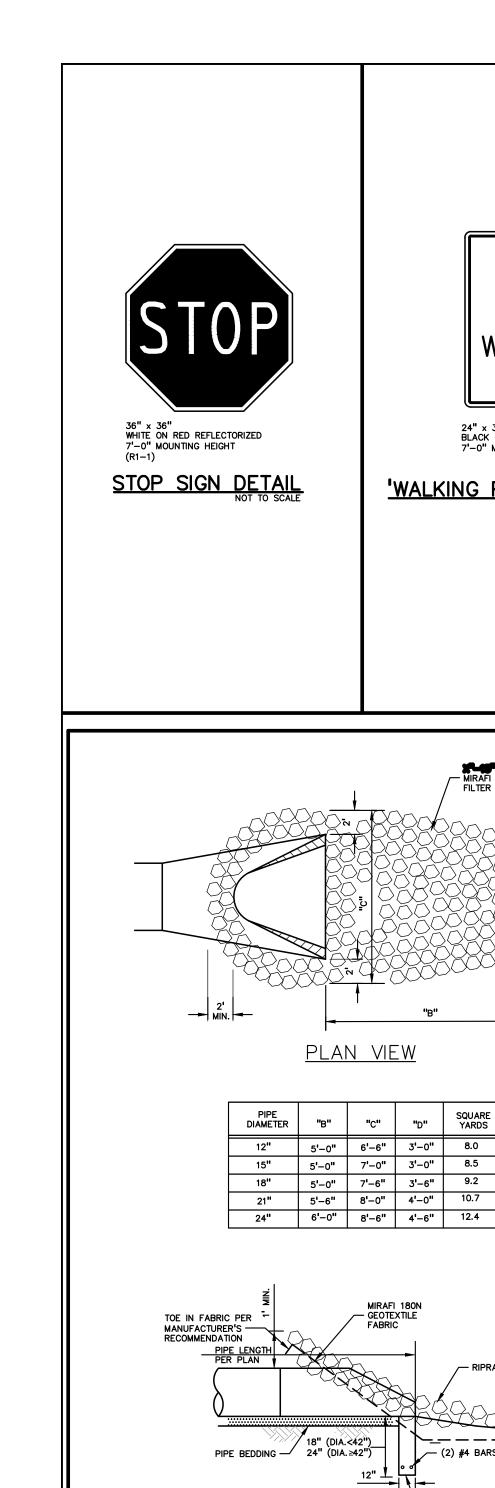
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GROUP

t: 844.813.2949


www.peagroup.com


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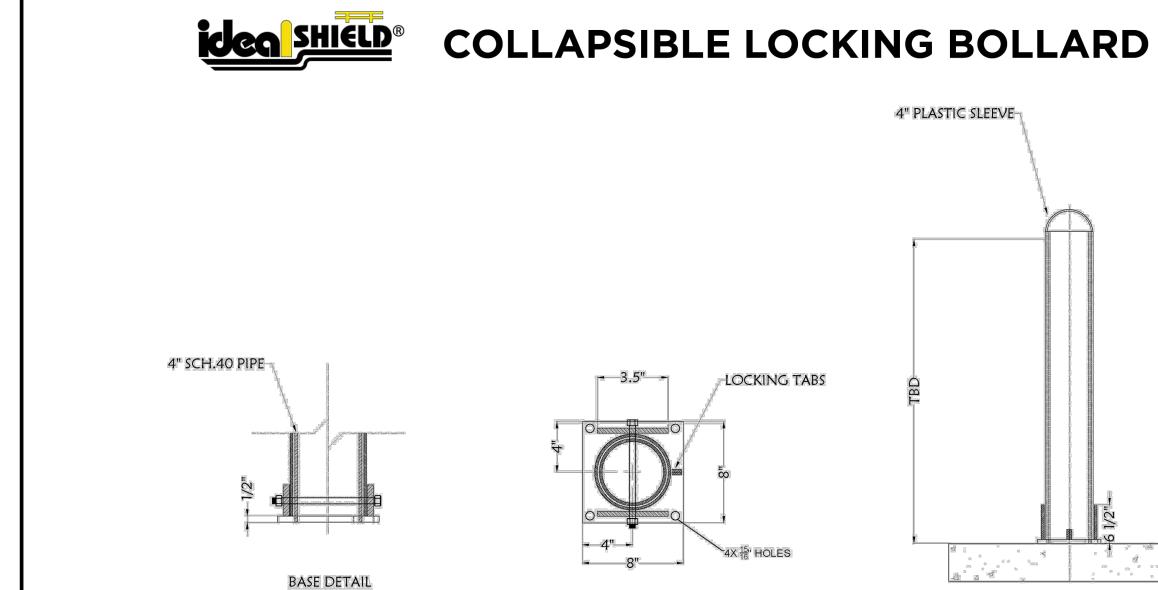



CONCRETE FOOTING fc


END SECTION & RIPRAP DETAIL




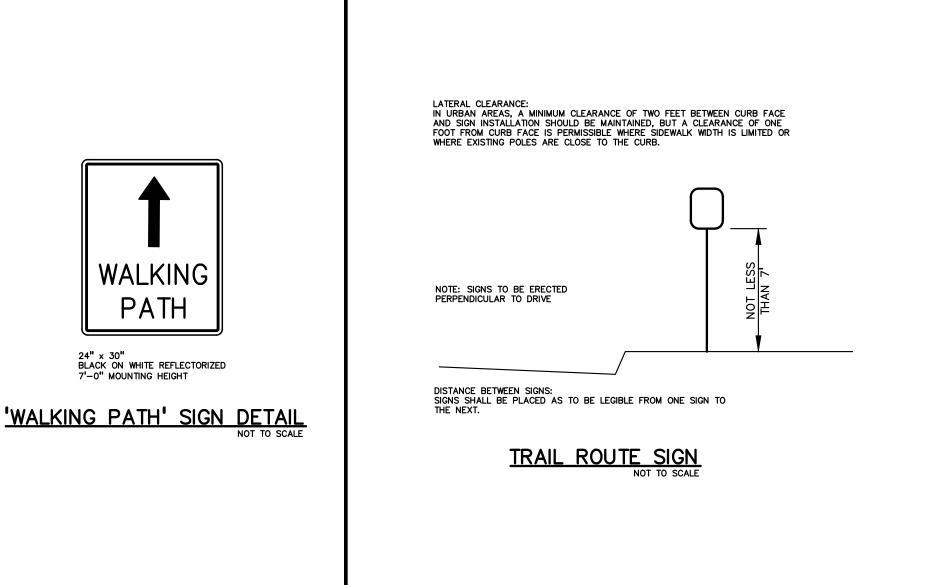

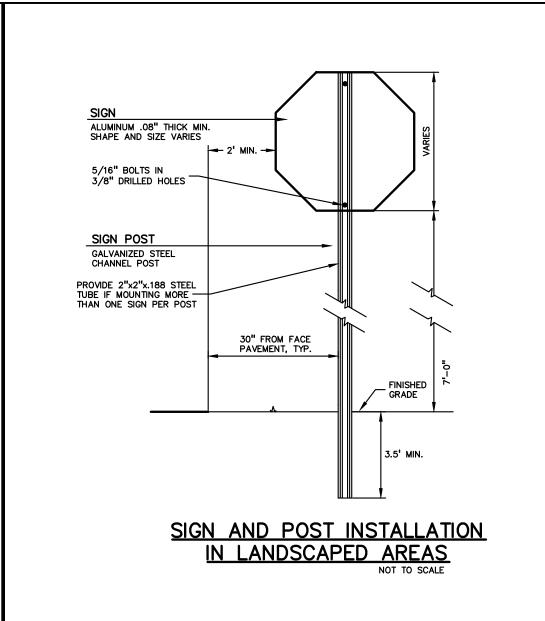


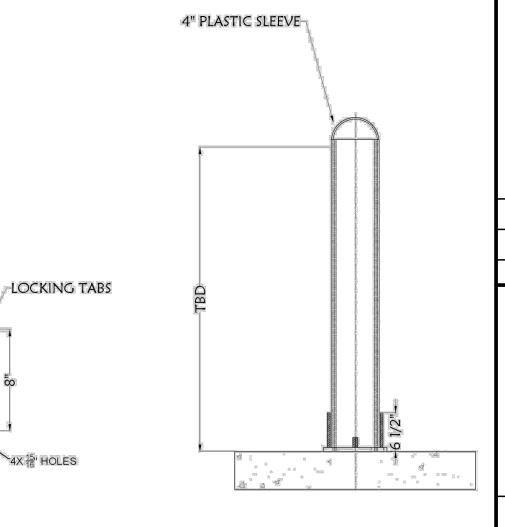

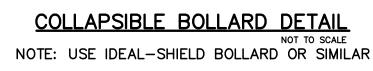

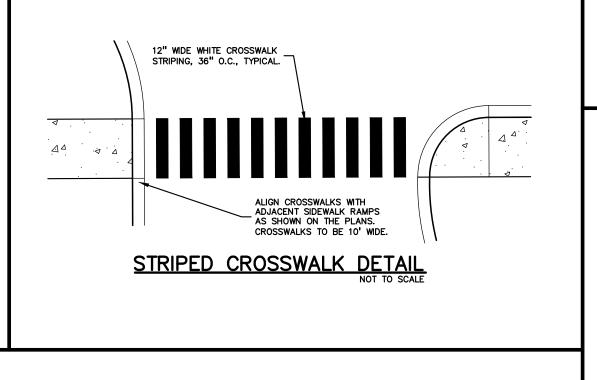



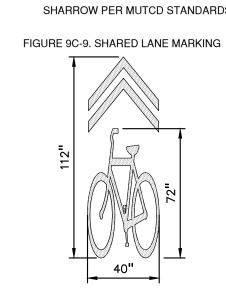


SHARROW DETAIL


If used in a shared lane with on-street should be placed so that the centers of the markings are at least 11 feet from the face of the curb, or from the edge of the pavement where there is no curb.

If used on a street without on-street parking that has an outside travel lane that is less than 14 feet wide, the centers of the Shared Lane Markings should be at least 4 feet from the face of the curb, or from the edge of the pavement where there is no curb.

If used, the Shared Lane Marking should be placed immediately after an intersection and spaced at intervals not greater than 250 feet thereafter.

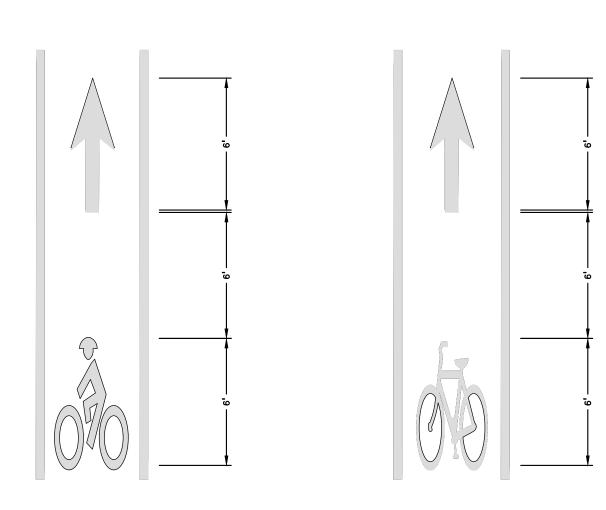

BIKE LANE SYBMOL MARKINGS

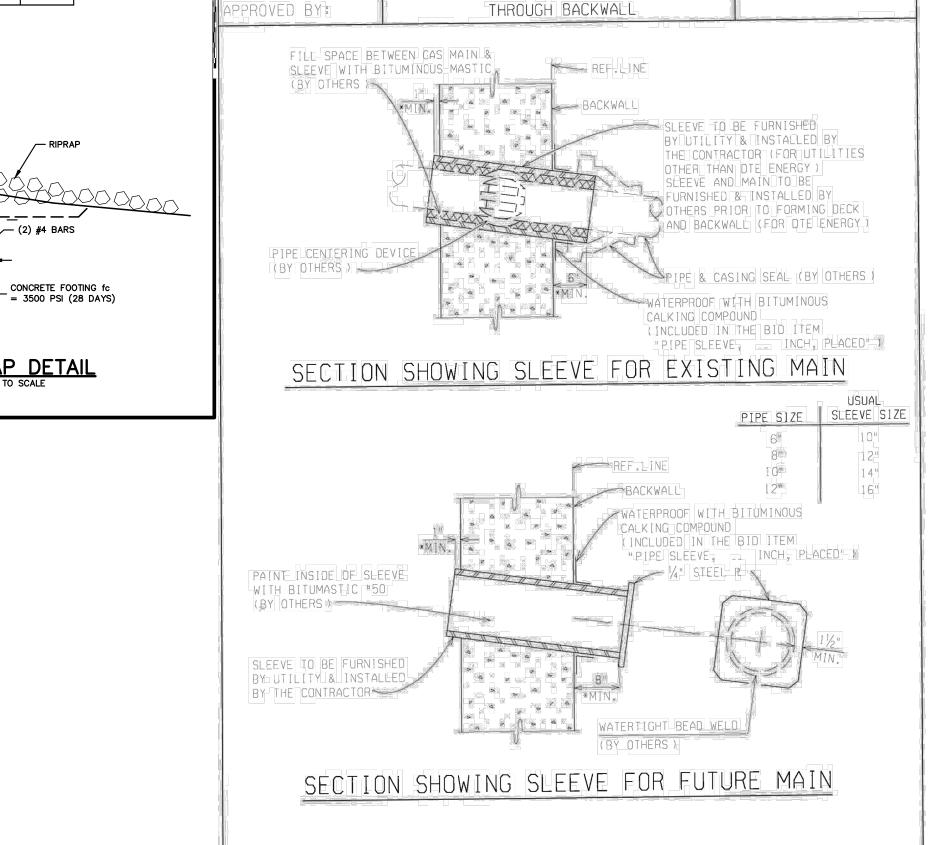

*1" FO" MINIMUM FOR DIE ENERGY


FORCEMAIN/GAS MAIN


BIKE LANE SIGN DETAILS

NOT TO SCALE

SUPERSEDES:08/15/0

9.40.01

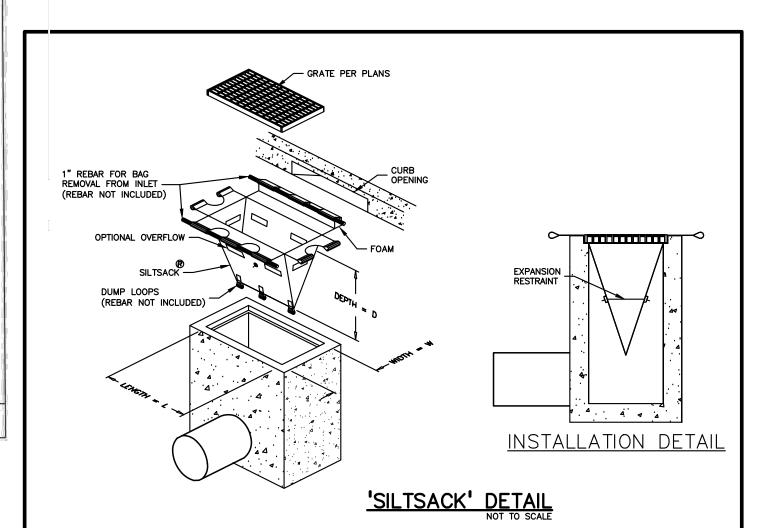

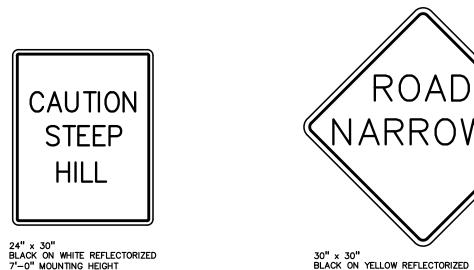


30" x 30" BLACK ON YELLOW REFLECTORIZED 7'-0" MOUNTING HEIGHT 'CAUTION STEEP HILL' **ROAD NARROWS** SIGN DETAIL
NOT TO SCALE SIGN DETAIL



SIDEWALK WARNING SIGN DETAIL



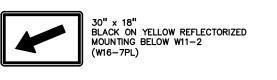

NOT FOR CONSTRUCTION XREF: S:PROJECTS\2019\2019-369 VAN BUREN IBT\DWG\SITE PLAN\19-369 VB PARKWAY PLANS\X-BASE D-19369.DWG
XREF: S:PROJECTS\2019\2019-369\DWG\SITE PLAN\19-369 VB PARKWAY PLANS\X-TBLK-19369.DWG

AIL SHEET TRAIL-SECTION BUREN $\overline{\mathbf{m}}$ RON

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CONSTRUCTION CONTRACTION AGREES THAT IN ACCORDANCE WITH GENERALLY ACCEPTED CONSTRUCTION PRACTICES, CONSTRUCTION CONTRACTOR WILL BE REQUIRED TO ASSUME SOLE AND COMPLETE RESPONSIBILITY FOR JOB SITE CONDITIONS DURING THE COURSE OF CONSTRUCTI

3 FULL WORKING DAYS BEFORE YOU DIG CALL


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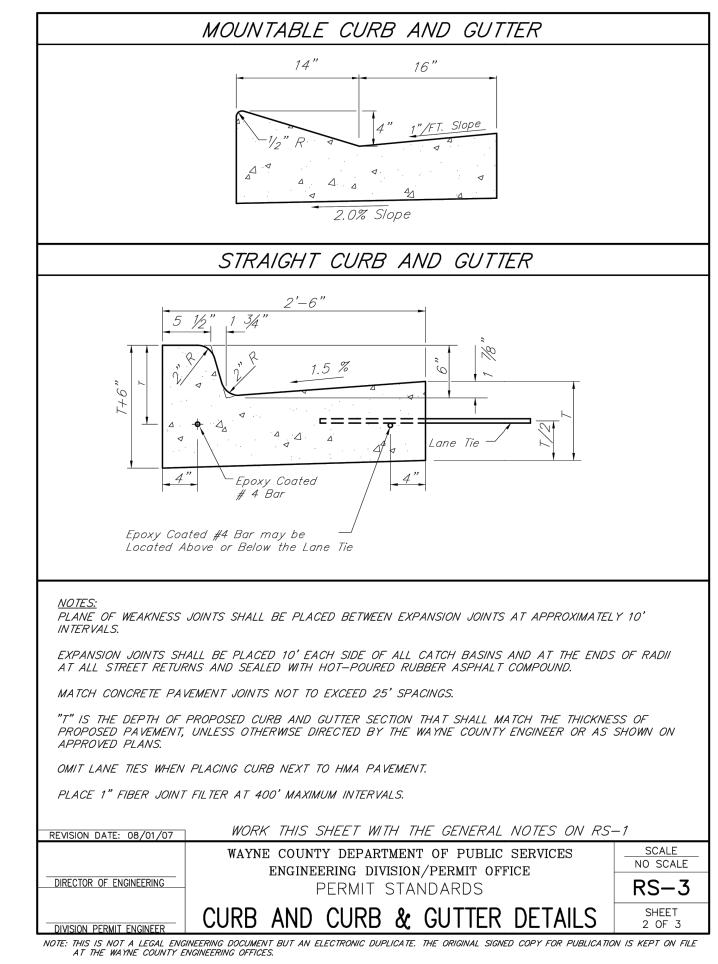
ORIGINAL ISSUE DATE: MARCH 19, 2021 PEA JOB NO. 2019-369


DRAWING NUMBER: C-5.2



All transverse joints in the concrete pavement shall extend entirely through the

integral curb and be of the same kind and thickness as provided for the pavement.

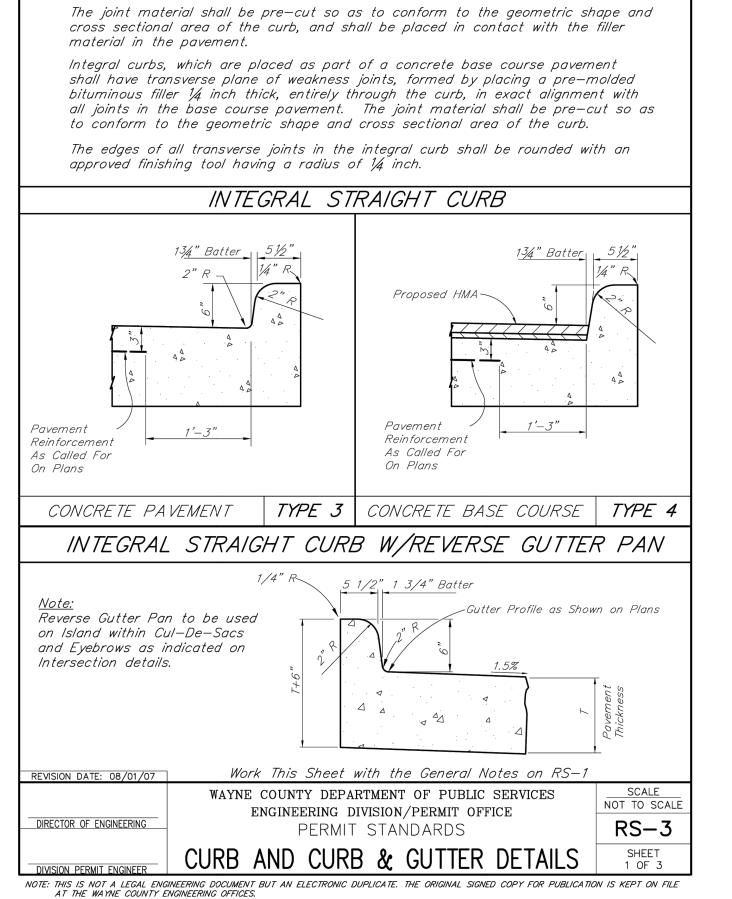

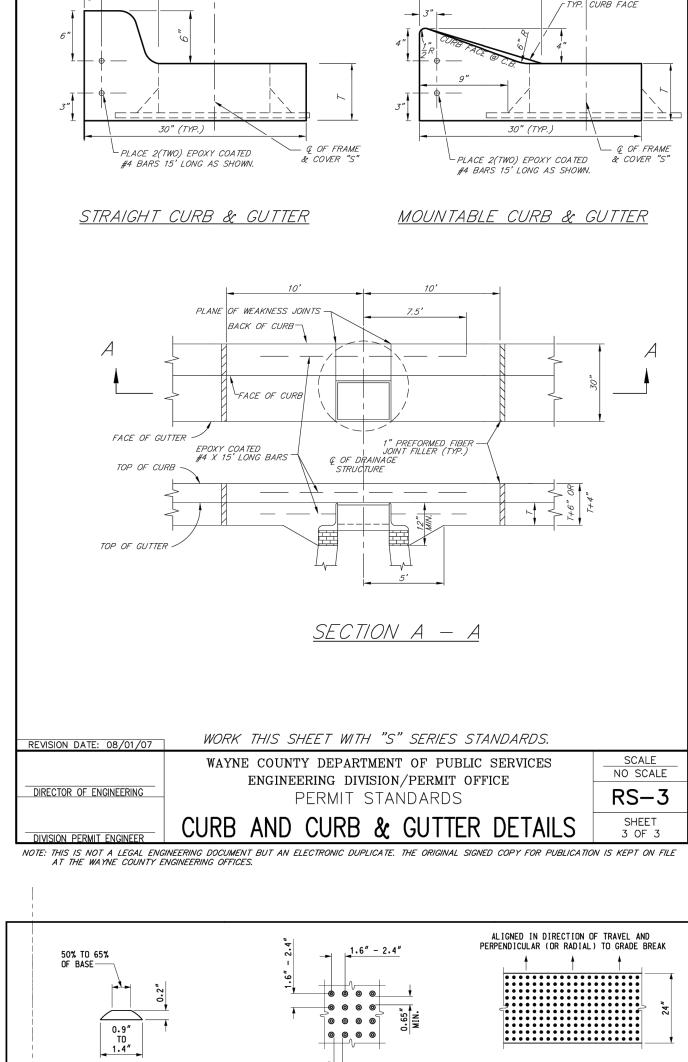

DOME SECTION

IN THE PUBLIC RIGHT OF WAY.

DETAILS SPECIFIED ON THIS PLAN APPLY TO ALL CONSTRUCTION.

RECONSTRUCTION, OR ALTERATION OF STREETS, CURBS, OR SIDEWALKS

SIDEWALK RAMPS ARE TO BE LOCATED AS SPECIFIED ON THE PLANS OR AS DIRECTED BY THE ENGINEER.

RAMPS SHALL BE PROVIDED AT ALL CORNERS OF AN INTERSECTION WHERE THERE IS EXISTING OR PROPOSED SIDEWALK AND CURB. RAMPS

SHALL ALSO BE PROVIDED AT MARKED AND/OR SIGNALIZED MID-BLOCK

SURFACE TEXTURE OF THE RAMP SHALL BE THAT OBTAINED BY A COARSE

SIDEWALK SHALL BE RAMPED WHERE THE DRIVEWAY CURB IS EXTENDED

CARE SHALL BE TAKEN TO ASSURE A UNIFORM GRADE ON THE RAMP. WHERE CONDITIONS PERMIT, IT IS DESIRABLE THAT THE SLOPE OF THE

RAMP BE IN ONLY ONE DIRECTION, PARALLEL TO THE DIRECTION OF

RAMP WIDTH SHALL BE INCREASED, IF NECESSARY, TO ACCOMMODATE

SIDEWALK SNOW REMOVAL EQUIPMENT NORMALLY USED BY THE

WHEN 5' MINIMUM WIDTHS ARE NOT PRACTICABLE, RAMP WIDTH MAY BE REDUCED TO NOT LESS THAN 4' AND LANDINGS TO NOT LESS THAN


DETECTABLE WARNING SURFACE COVERAGE IS 24" MINIMUM IN THE DIRECTION OF RAMP/PATH TRAVEL AND THE FULL WIDTH OF THE RAMP/PATH OPENING EXCLUDING CURBED OR FLARED CURB TRANSITION AREAS. A BORDER OFFSET NOT GREATER THAN 2" MEASURED ALONG


FOR NEW ROADWAY CONSTRUCTION, THE RAMP CROSS SLOPE MAY NOT EXCEED 2.0%. FOR ALTERATIONS TO EXISTING ROADWAYS, THE CROSS SLOPE MAY BE TRANSITIONED TO MEET AN EXISTING ROADWAY GRADE.

THE CROSS SLOPE TRANSITION SHALL BE APPLIED UNIFORMLY OVER THE

CURB THE OFFSET IS MEASURED FROM THE ENDS OF THE RADIUS.

BROOMING, TRANSVERSE TO THE RUNNING SLOPE.

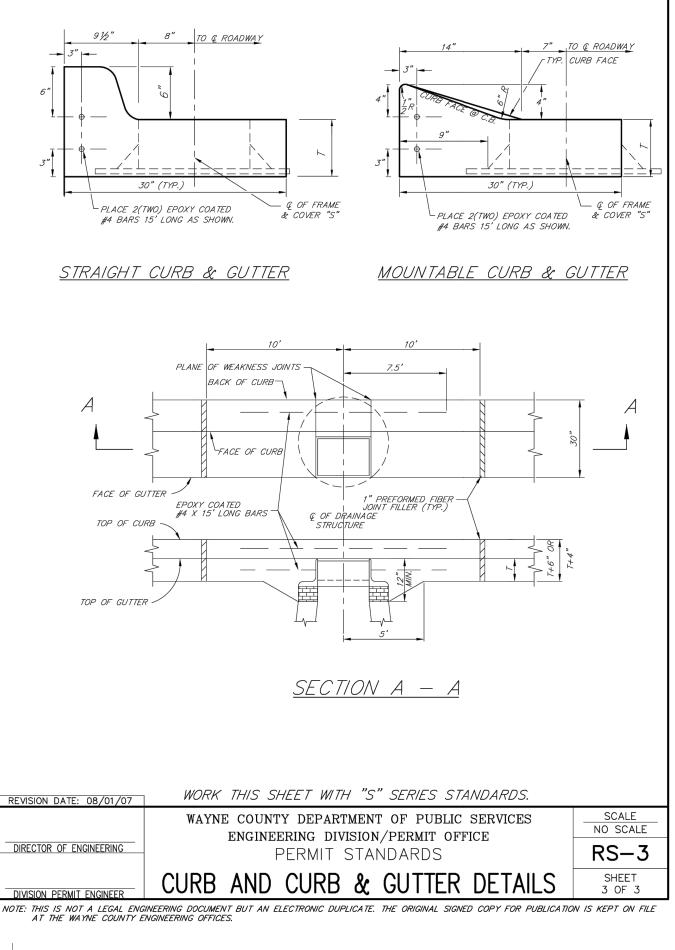

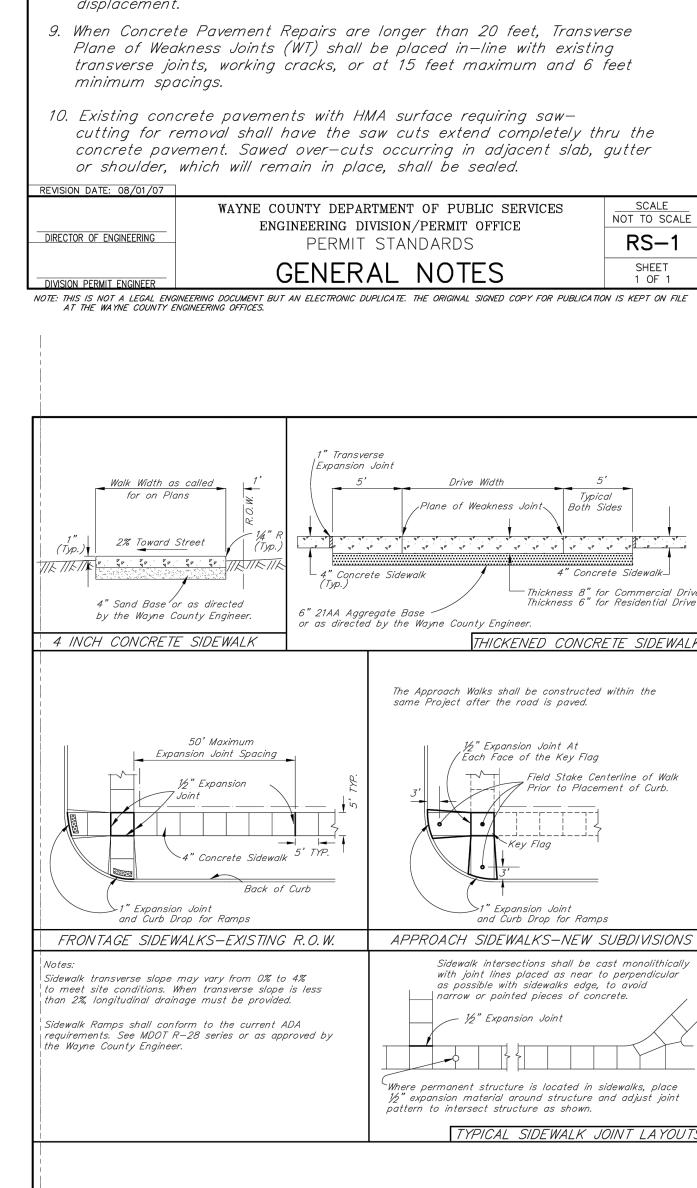

1. All materials and workmanship shall be in accordance with Wayne County

2. Paving Standard Plan Details may be shown with wire fabric reinforcement.

3. A Transverse End of Pour Joint, Symbol (H), shall be constructed when

accordance with current MDOT Standard Plan, R-39 series (Reinforced

This note applies to both concrete base and finished concrete pavement.

4. When it is anticipated that construction traffic will be using the pavement,

endings will be protected by means of a temporary concrete header as

Specifications which are defined as the current Michigan Department of Transportation (MDOT) Standard Specifications for Construction as

Use of reinforcement shall be required as called for on the plans.

there is an interruption in concrete paving for more than 1/2 hour.

Transverse End of Pour Joint, Symbol (H), shall be constructed in

Concrete Pavement) and R-39P series (Plain Concrete Pavement).

5. The Expansion Joint Foam Rod shall be a solid round heat resistant Polyurethane foam capable of withstanding the temperature of the

6. Wire Fabric Reinforcement shall lay flat when delivered to the work

standards, special sheets of the required width may be used

area. The use of spreader bars will be required for lifting bundles of

or standard sheets may be cut to the required size or split sheets

may be added to standard sheets to obtain the required size. Side

8. The ends of the Wire Fabric Reinforcement sheets shall be fastened in

at least two places at each lap to prevent horizontal and vertical

laps shall not be less than the spacing of the longitudinal wires.


7. Where the lane width of the pavement differs from wire fabric reinforcement


sealant. Density of the foam shall be 2-4 Lb/Cft.


modified by Wayne County Special Provisions.

shown on RS-4.

reinforcement.

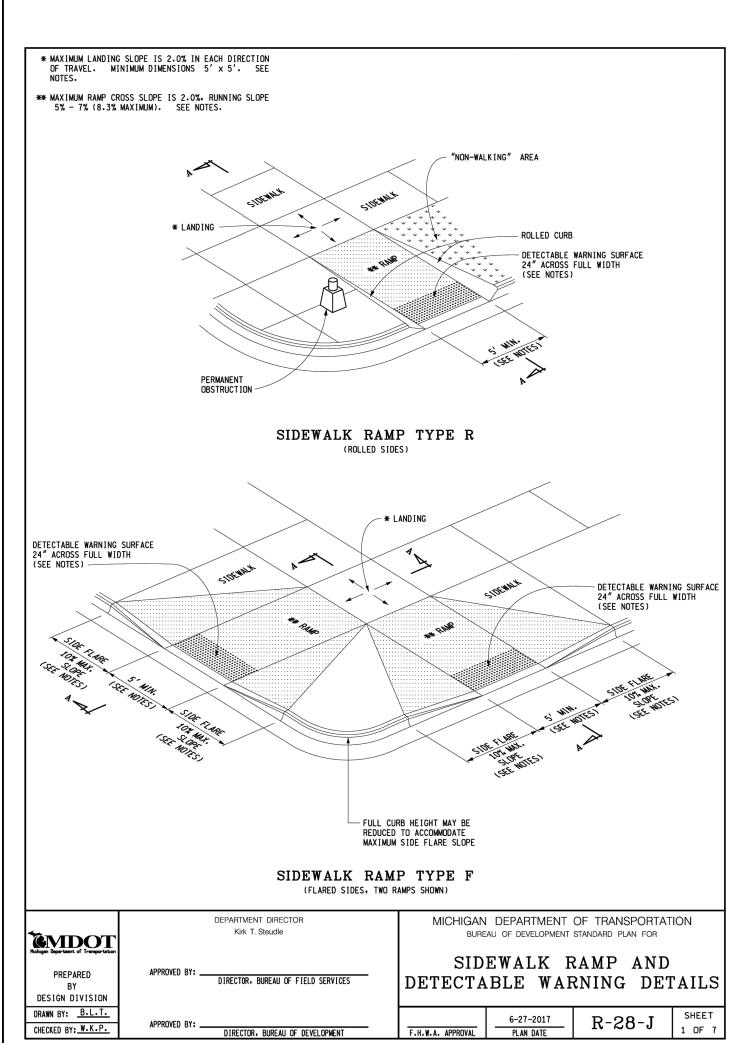

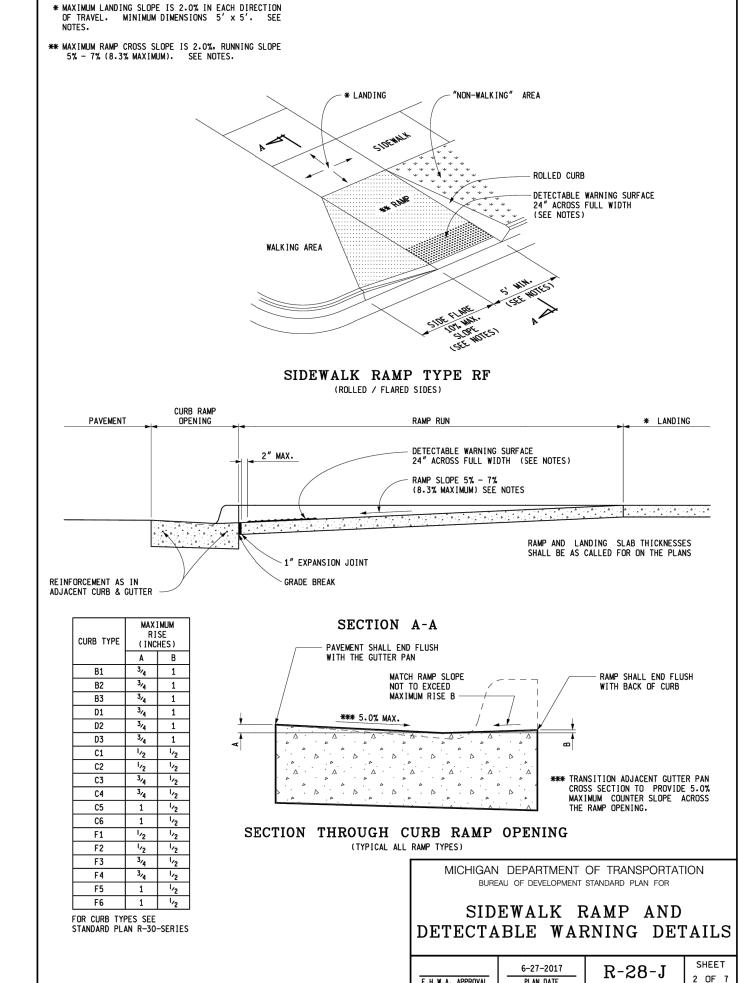

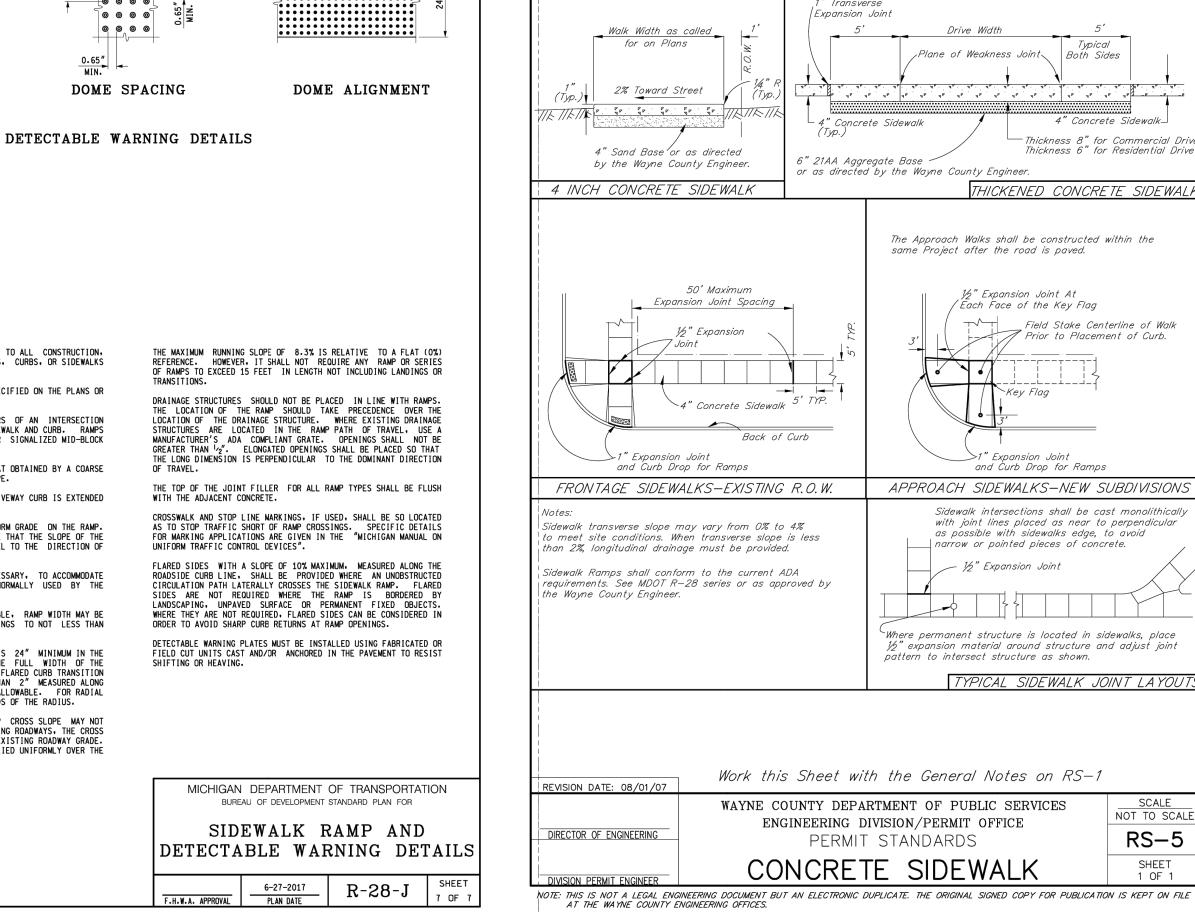

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ORIGINAL ISSUE DATE: MARCH 19, 2021 PEA JOB NO. 2019-369

DRAWING NUMBER:


NOT FOR CONSTRUCTION XREF: S:PROJECTS\2019\2019-369 VAN BUREN IBT\DWG\SITE PLAN\19-369 VB PARKWAY PLANS\X-SURF D-19369.DWG XREF: S:PROJECTS\2019\2019-369 VAN BUREN IBT\DWG\19369-TOPOBASE.DWG XREF: S:PROJECTS\2019\2019-369 VAN BUREN IBT\DWG\SITE PLAN\19-369 VB PARKWAY PLANS\X-BASE D-19369.DWG XREF: S:PROJECTS\2019\2019-369\DWG\SITE PLAN\19-369 VB PARKWAY PLANS\X-TBLK-19369.DWG

RS-5

ENGINEERING DIVISION/PERMIT OFFICE

PERMIT STANDARDS

CONCRETE SIDEWAL

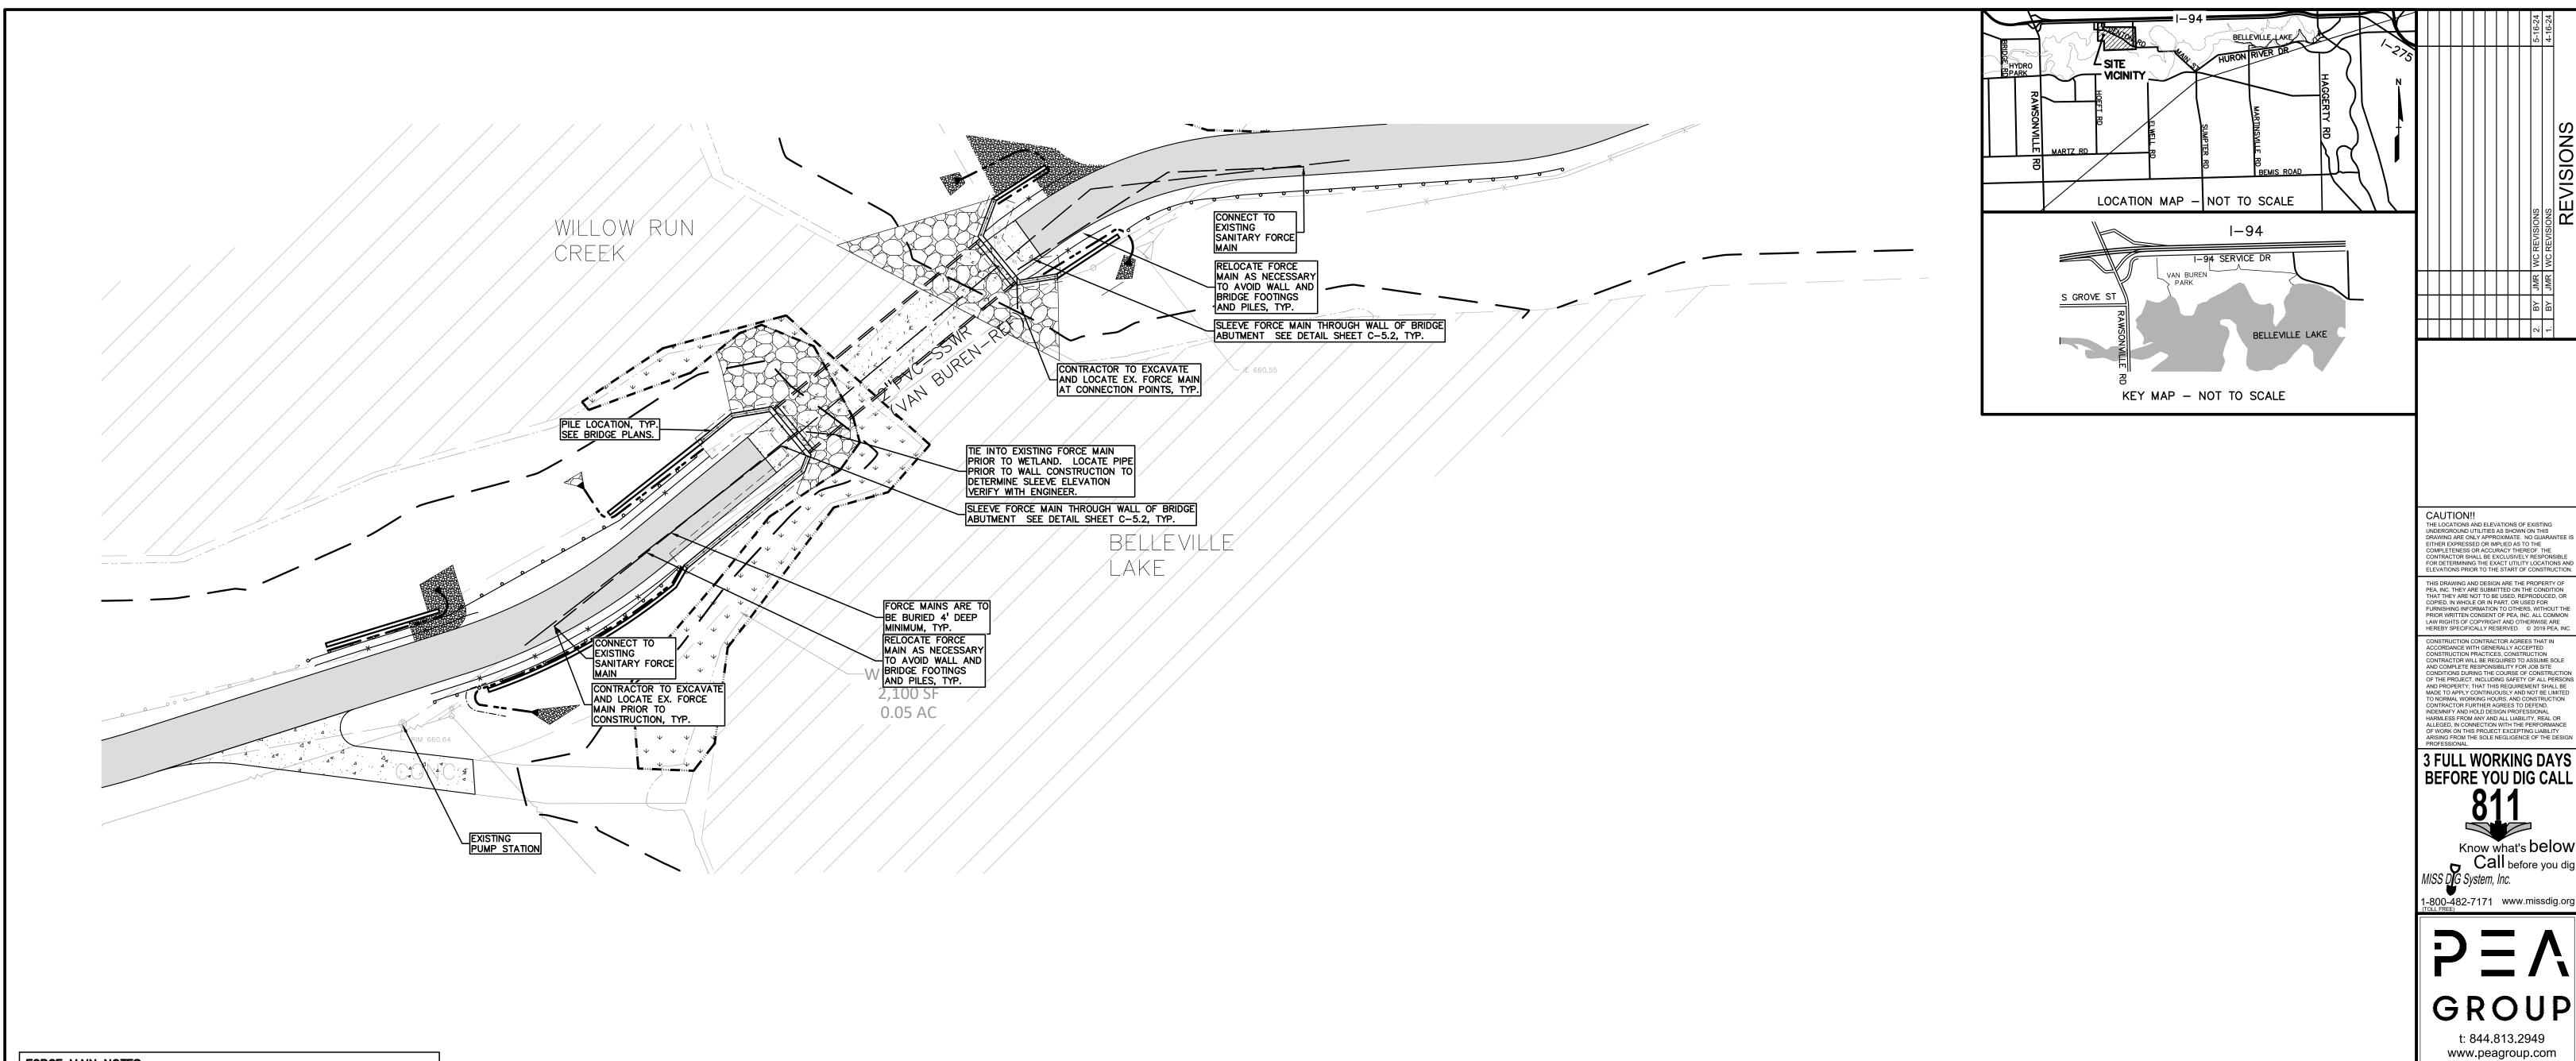

FORCE MAIN NOTES:

- CONTRACTOR IS TO COORIDNATE WITH THE TOWNSHIP DPW THE LOCATE THE EXISTING FORCE MAIN ALONG THE ABUTMENTS AND WALLS WHERE PILES ARE REQUIRED. DEPTH AND LOCATION ARE NECESSARY TO DETERMINE CONFLICTS
- WITH THE PROPOSED ABUTMENT AND WALL. REFER TO BRIDGE PLANS.

 2. IF CONFLICTS ARE PRESENT WITH THE FORCE MAIN AND THE PROPOSED HELICAL PILES, CONTRACTOR IS TO FIELD CORRECT. CONTACT PEA TO COORDINATE A SITE MEETING WITH STRUCTURAL ENGINEER AND TOWNSHIP DPW.
- RELOCATION OF THE FORCE MAIN MAY BE REQUIRED. PLANS IDENTIFY A POSSIBLE LOCATION TO AVOID PILES.
- . CONTRACTOR IS TO CONSIDER ALL COST THAT MAY BE ASSOCIATED WITH THIS ALTERNATE CONSTRUCTION METHOD AND INCLUDE IN THE COST PER LINEAR
- FOOT OF FORCE MAIN.

 IF A RELOCATION OF THE FORCE MAIN IS REQUIRED, BY PASS PUMPING IS INCIDENTAL TO THE COST OF 2" SANITARY SEWER FORCE MAIN. IT IS NOTED
- THE FORCE MAIN IS OUT OF SERVICE IN THE LATE FALL/WINTER. 6. IF RELOCATION OF THE FORCE MAIN IS REQUIRED, UNDER THE STREAM A PERMIT FROM EGLE WILL BE REQUIRED AND A MINIMUM DELAY OF 4 MONTHS IS

ALL WORK IS TO BE DONE IN CONFORMANCE WITH VAN BUREN TOWNSHIP'S ENGINEERING STANDARDS.

Method - OPEN CUT

NOT FOR CONSTRUCTION


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XREF: S:PROJECTS\2019\2019-369\DWG\SITE PLAN\19-369 VB PARKWAY PLANS\X-TBLK-19369.DWG

ORIGINAL ISSUE DATE: MARCH 19, 2021 PEA JOB NO. 2019-369

> 1"=20' DRAWING NUMBER: C-6.1

FORCE MAIN RELOCATION 1
IRON BELLE TRAIL-SECTION D

VAN BUREN TOWNSHIP

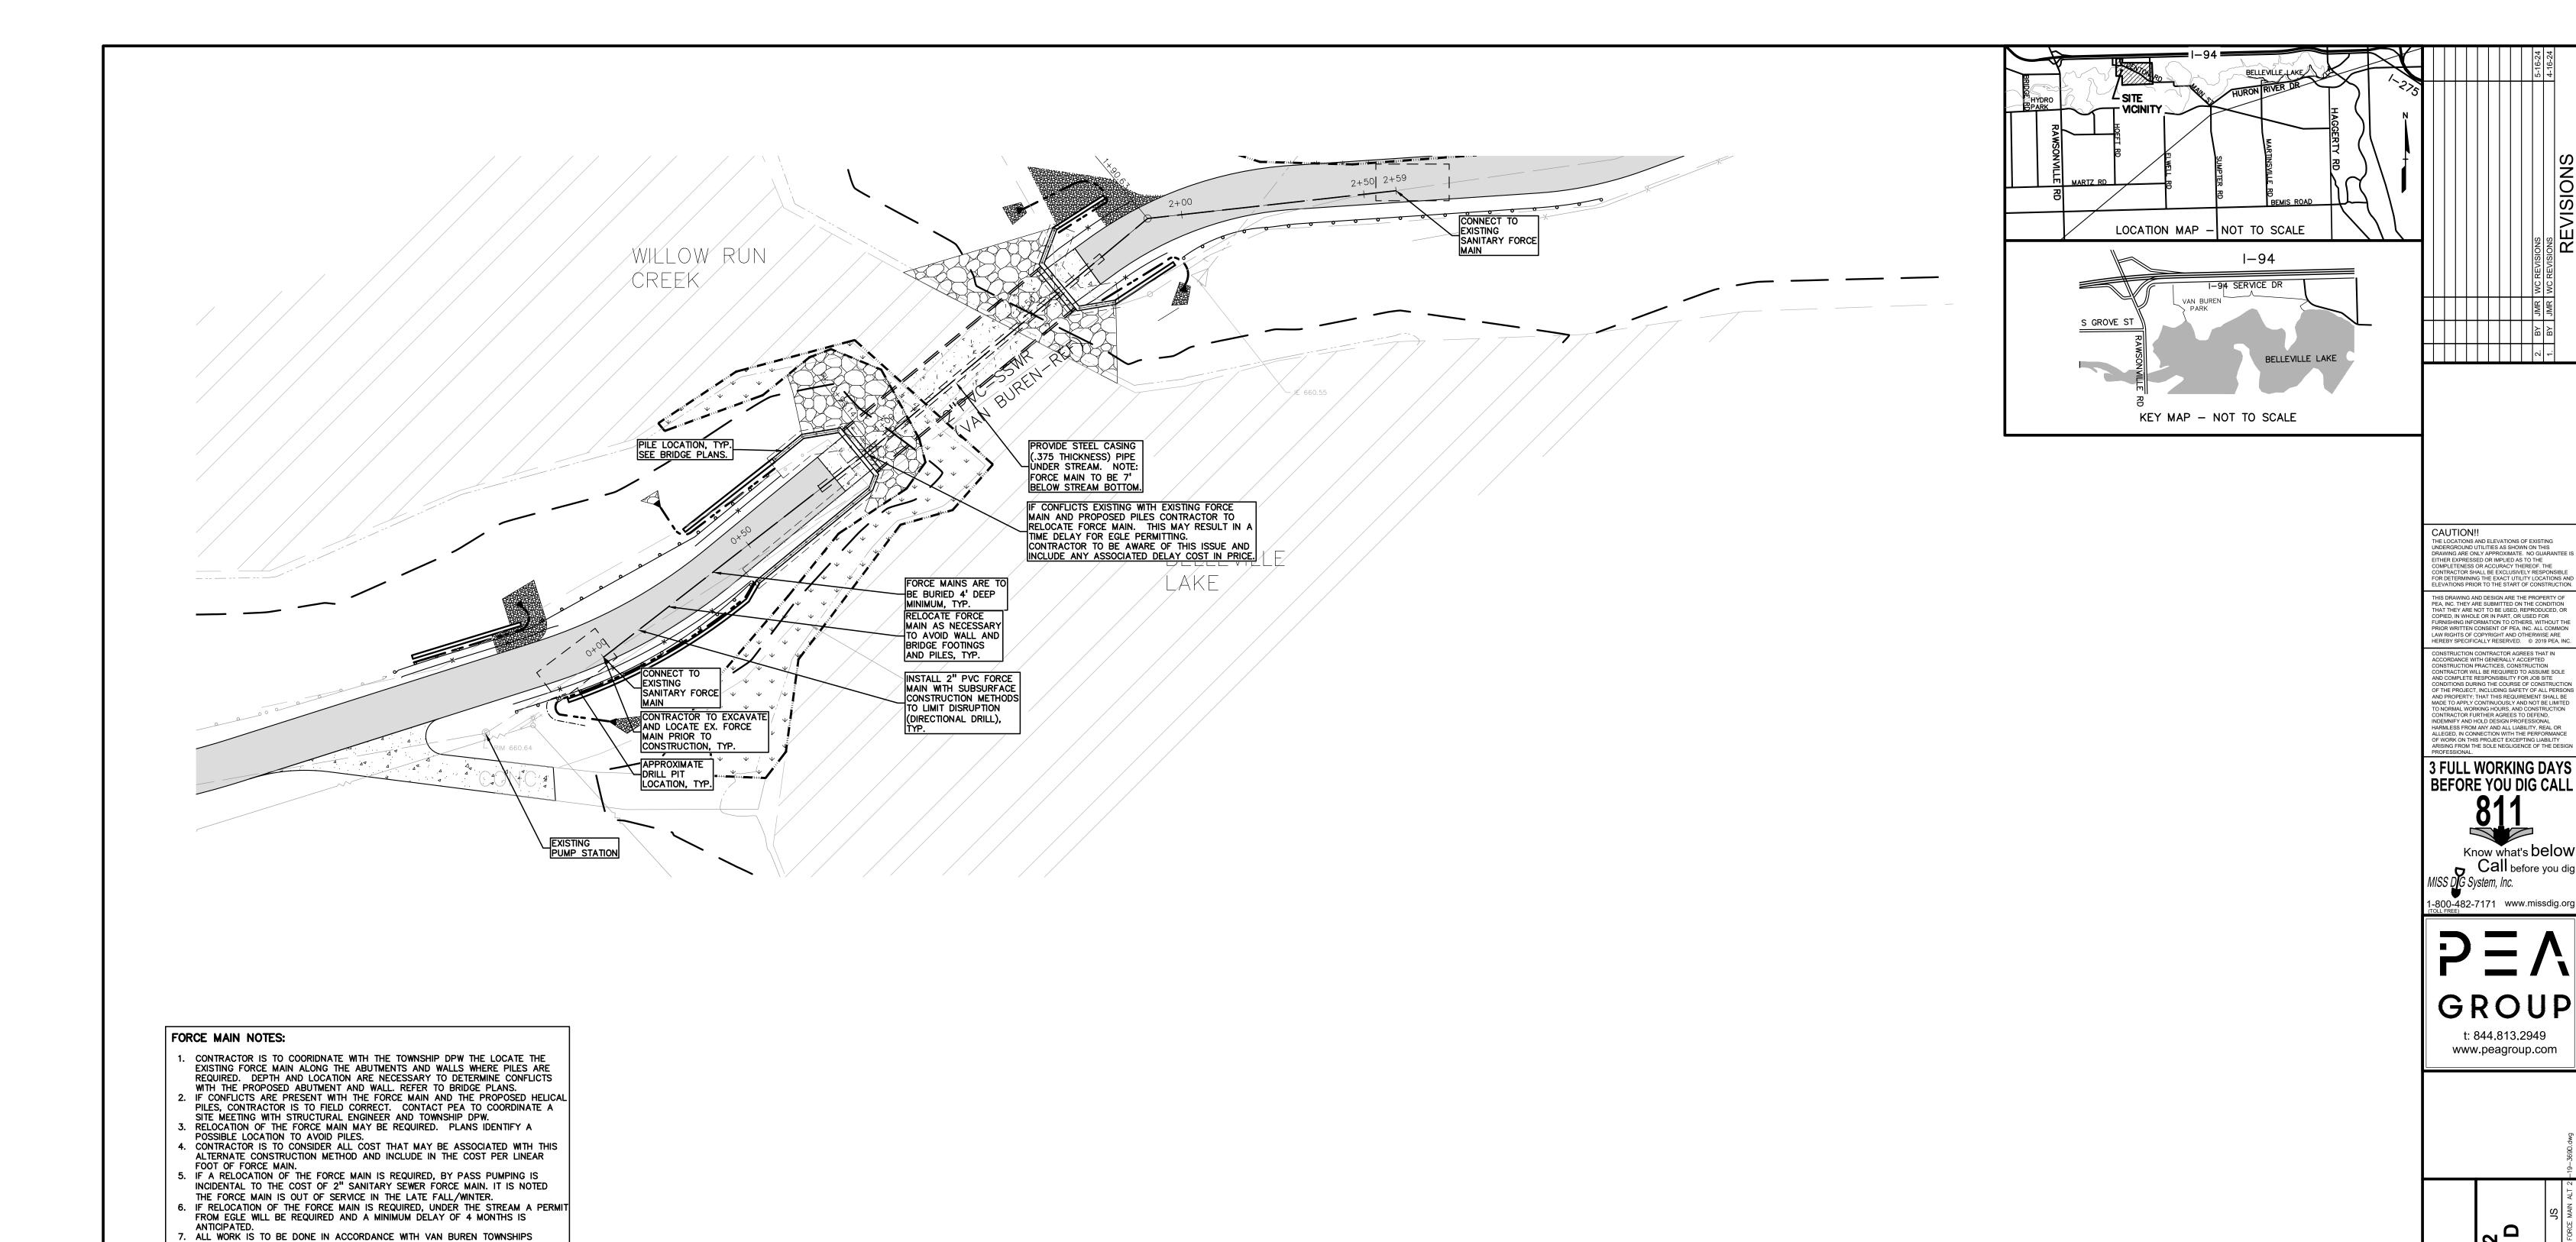

ENGINEERING STANDARDS AND EGLE REQUIREMENTS.

Method - SUBSURFACE

NOT FOR CONSTRUCTION

XREF: S:PROJECTS\2019\2019-369 VAN BUREN IBT\DWG\SITE PLAN\19-369 VB PARKWAY PLANS\X-SURF D-19369.DWG
XREF: S:PROJECTS\2019\2019-369 VAN BUREN IBT\DWG\19369-TOPOBASE.DWG XREF: S:PROJECTS\2019\2019-369 VAN BUREN IBT\DWG\SITE PLAN\19-369 VB PARKWAY PLANS\X-BASE D-19369.DWG

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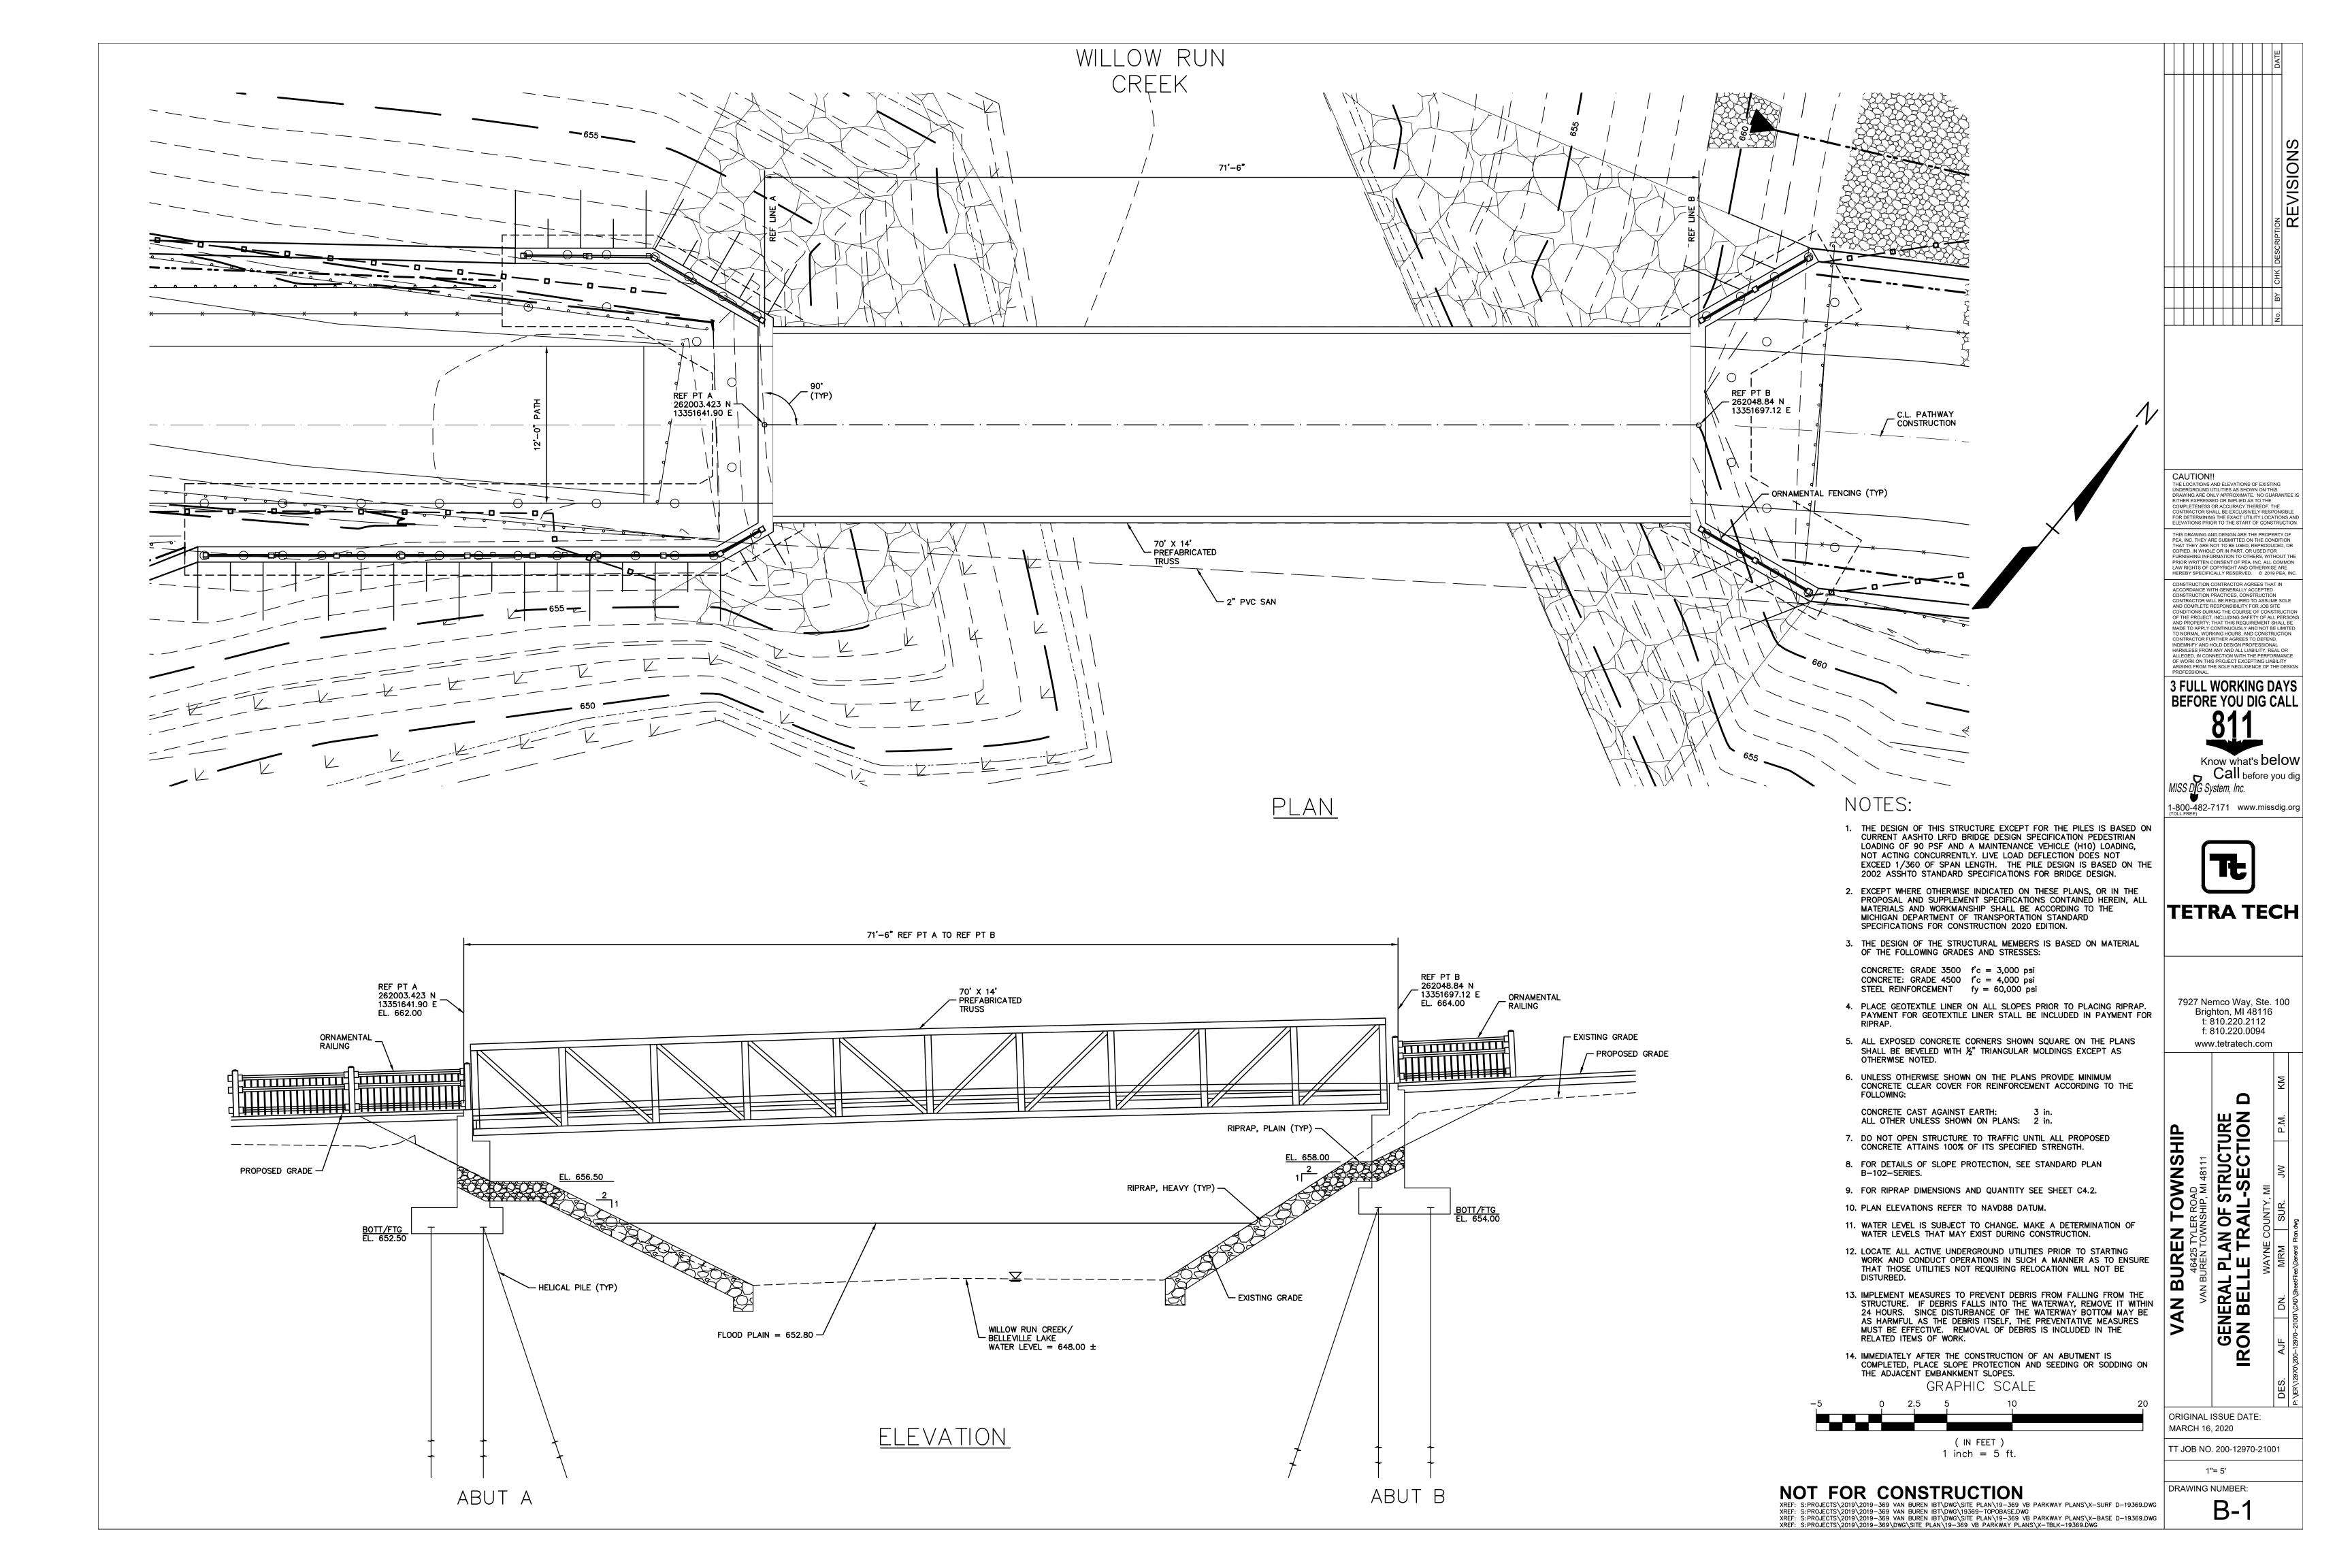
PEA JOB NO. 2019-369 1"=20'


ORIGINAL ISSUE DATE: MARCH 19, 2021


DRAWING NUMBER: C-6.2

FORCE MAIN RELOCATION RON BELLE TRAIL-SECTION

VAN BUREN TOWNSHIP




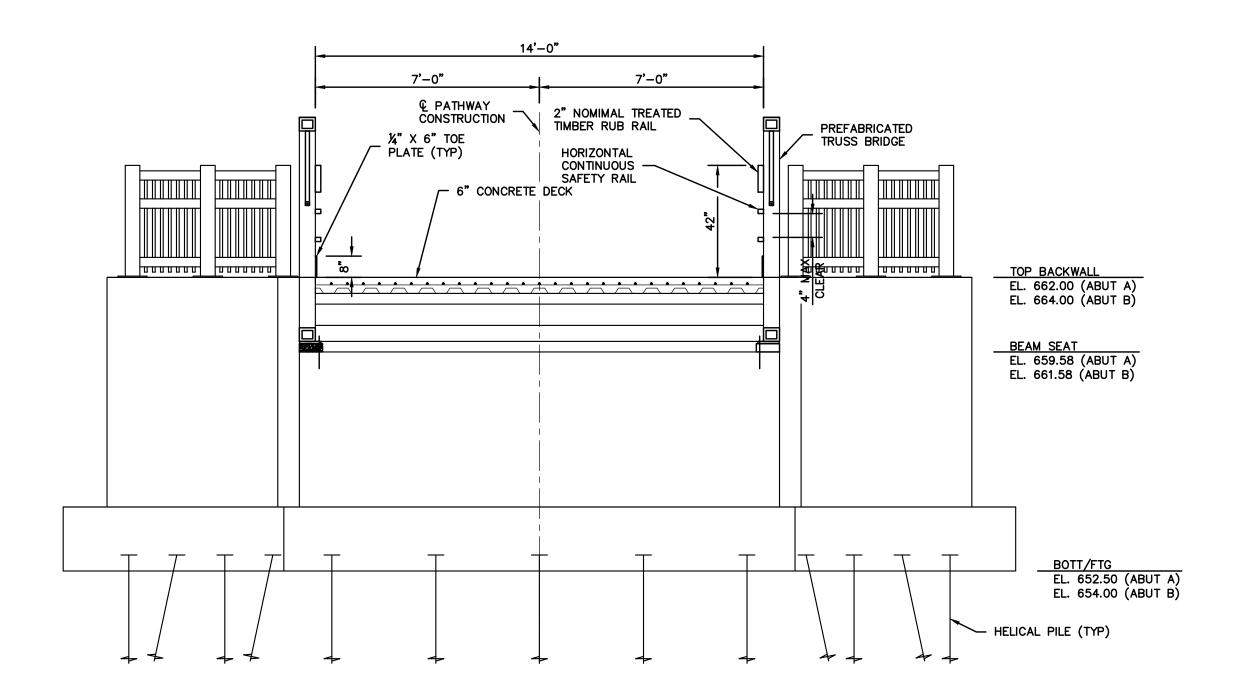

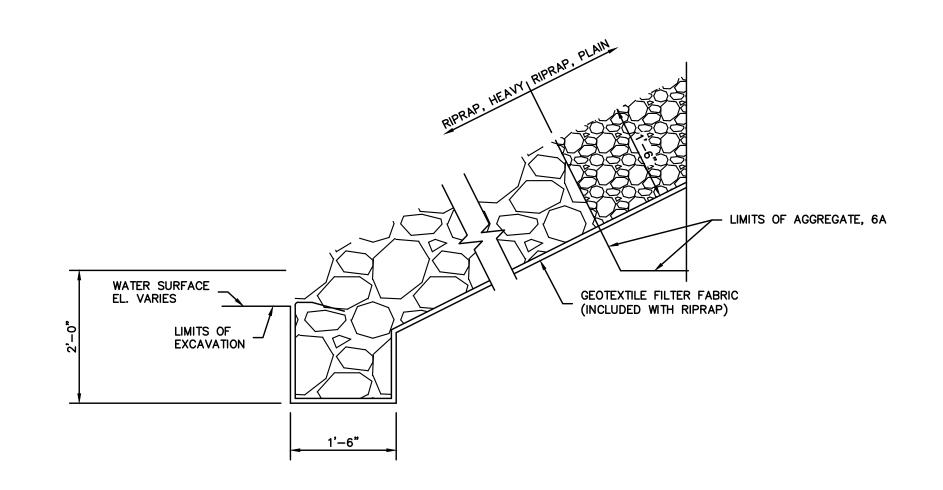



TYPICAL SECTION




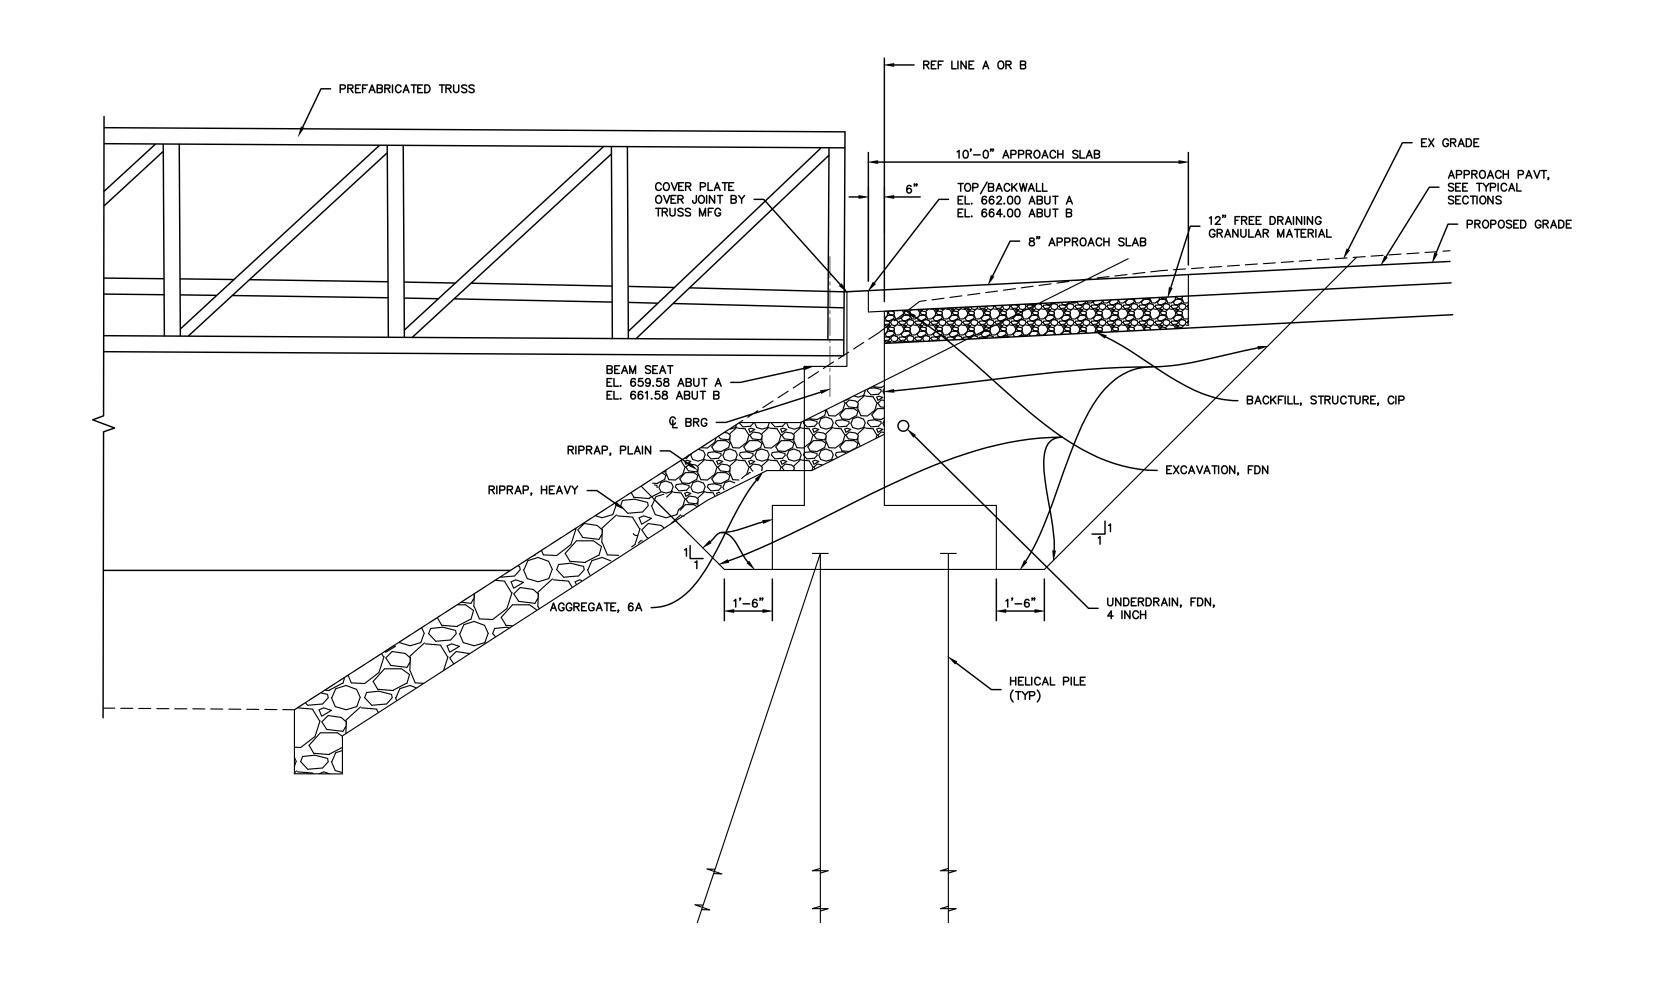

ABUTMENT SECTION

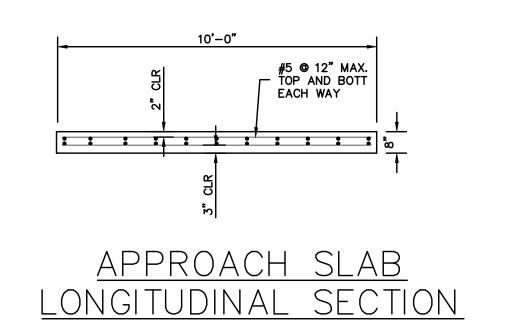

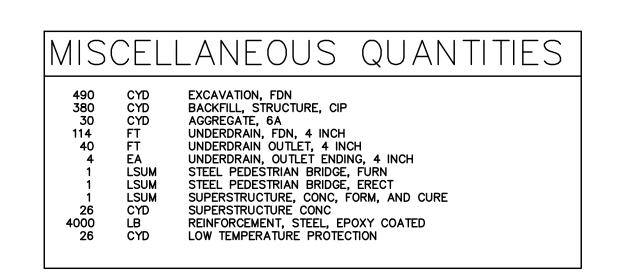

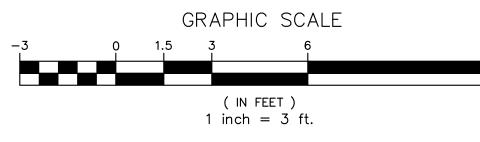

1"= 3' DRAWING NUMBER:

CAUTION!!

THE LOCATIONS AND ELEVATIONS OF EXISTING UNDERGROUND UTILITIES AS SHOWN ON THIS DRAWING ARE ONLY APPROXIMATE. NO GUARANTEE IS EITHER EXPRESSED OR IMPLIED AS TO THE COMPLETENESS OR ACCURACY THEREOF. THE CONTRACTOR SHALL BE EXCLUSIVELY RESPONSIBLE FOR DETERMINING THE EXACT UTILITY LOCATIONS AND ELEVATIONS PRIOR TO THE START OF CONSTRUCTION.

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PLAN OF STRUCTURE LE TRAIL-SECTION

GENERAL PIRON BELLE

ORIGINAL ISSUE DATE:

TT JOB NO. 200-12970-21001

B-2

MARCH 16, 2020

TOWNSHIP ER ROAD

BUREN

VAN

NOT FOR CONSTRUCTION

XREF: S:PROJECTS\2019\2019-369 VAN BUREN IBT\DWG\SITE PLAN\19-369 VB PARKWAY PLANS\X-SURF D-19369.DWG

XREF: S:PROJECTS\2019\2019-369 VAN BUREN IBT\DWG\19369-TOPOBASE.DWG

XREF: S:PROJECTS\2019\2019-369 VAN BUREN IBT\DWG\SITE PLAN\19-369 VB PARKWAY PLANS\X-BASE D-19369.DWG

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